

IBI GROUP
1001 Wilshire Boulevard, Suite 100-3100,
Los Angeles, CA 90017, USA
tel 213 769 0011 fax 213 769 0016
ibigroup.com

COPYRIGHT

This drawing has been prepared solely for the intended use, thus any reproduct or distribution for any purpose other than authorized by IBI Group is forbidder Written dimensions shall have precedence over scaled dimensions. Contractor shall verify and be responsible for all dimensions and conditions on the job, and Group shall be informed of any variations from the dimensions and conditions shown on the drawing. Shop drawings shall be submitted to IBI Group for gene conformance before proceeding with fabrication.

IBI Group, A California Partnership is a member of the IBI Group of companies

CONSULTANT:

STATE SEAL:



HEADQUARTERS BUILDING PHYSICAL SECURITY IMPROVEMENTS

PROJECT
HEADQUARTERS
BUILDING
EXTERIOR
PHYSICAL
SECURITY
IMPROVEMENTS

SPECIFICATION NO.: 2003
PROJECT NUMBER: 105168
DRAWING NUMBER:
APPROVAL SHEET NO.:

ADDRESS: 700 N. ALAMEDA ST. LOS ANGELES, CA 90012

REVISIONS:
DELTA TITLE DATE BY

PROJECT TEAM

OWNER:
METROPOLITAN WATER DISTRICT
700 N ALAMEDA STREET
LOS ANGELES, CA 90012
PHONE: (213) 217-7080

CONTACT: MIKE CLAISSE PROJECT MANAGER

ARCHITECT:

IBI GROUP
315 W 9TH STREET
LOS ANGELES, CA 90015
PHONE: (213) 769-0011
FAX: (213) 769-0016

CONTACT: CRAIG ATKINSON
ARCHITECT OF RECORD

STRUCTURAL:

ABS CONSULTING
300 COMMERCE DRIVE, SUITE 150
IRVINE, CA 92602
PHONE: (714) 734-2583
FAX:

CONTACT: TRACY RICH
PROJECT MANAGER

PM:	GENERAL
PE:	
SENIOR TECH. MGR.:	
DRAWN BY:	AO
SCALE:	
DATE:	04/22/21
JOB NO.:	116535

COVER SHEET

SHEET NO.:

G0000

ABBREVIATIONS APPLICABLE CODES CALIFORNIA CODE OF REGULATIONS, TITLE 24 - BUILDING STANDARDS - ACCESSIBLE - MEHCNAICAL 2019 CALIFORNIA ADMINISTRATIVE CODE (CAC) (Title 24, Part 1, CCR) - ANCHOR BOLT - MEDIUM 2019 CALIFORNIA BUILDING CODE (CBC), Volumes 1 & 2 (Title 24, Part 2, CCR) - ASPHALT CONCRETE - MANUFACTURING (2018 International Building Code with 2018 California amendments) MFR - AIR CONDITIONING - MANUFACTURER 2019 CALIFORNIA ELECTRICAL CODE, Title 24, Part 3, CCR) - ACOUSTICAL MIN (2018 National Electrical Code with 2018 California amendments MIR - MIRROR ADDENDUM 2019 CALIFORNIA MECHANICAL CODE (CMC), Title 24, Part 4, CCR) MISC MOD MNT - ADJUSTABLE or - MISCELLANEOUS (2018 Uniform Mechanical Code with 2018 California amendments) ADJACENT - MODULAR **2019 CALIFORNIA PLUMBING CODE (CPC)**, Title 24, Part 5, CCR) AGGREGATE - MOUNT (ED), (ING) (2018 Uniform Plumbing Code with 2018 California amendments) - ALTERNATE MTL **2019 CALIFORNIA ENERGY CODE,** (Title 24, Part 6) - ALUMINUM - MULLION 2019 CALIFORNIA HISTORICAL BUILDING CODE, (Title 24, Part 8, CCR) - APPROVED (2018 International Building Code with 2018 California amendments) - APPROXIMATE **2019** CALIFORNIA FIRE CODE (CFC), Title 24, Part 9, CCR) - ARCHITECT (URAL) - NOT IN CONTRACT (2018 International Fire Code with 2018 California amendments) - NUMBER **2019 CALIFORNIA EXISTING BUILDING CODE,** (Title 24, Part 10, CCR) NOM - NOMINAL (2018 International Existing Building Code with 2018 California amendments) NPS NTS - BELOW - NOMINAL PIPE SIZE 2019 CALIFORNIA GREEN BUILDING STANDARDS CODE (CALGREEN), - BUILDING - NOT TO SCALE Title 24, Part 11, CCR) - 2018 California Green Building Standards Code - BLOCKING applies at those portions designated by California Building Standards - BOTTOM - BUILT UP ROOFING - ON CENTER **2019 CALIFORNIA REFERENCE STANDARDS CODE**, (Title 24, Part 12, CCR) - OUTSIDE DIAMETER - OVERFLOW DRAIN 2010 ADA STANDARDS FOR ACCESSIBILITY DESIGN, U.S. Department of Justice OWNER FURNISHED CONTRACTOR - CATCH BASIN 2016 NFPA 13, STANDARD FOR THE INSTALLATION OF SPRINKLER CEM - CEMENT INSTALLED - CUBIC FOOT OWNER FURNISHED - COUNTERFLASHING OWNER INSTALLED 2016 NFPA 72, NATIONAL FIRE ALARM CODE AND SIGNALING CODE, 2015 Edition - OPPOSITE CHAMFER - OPTIONAL - CONTROL JOINT NOTE: SOME CODES MAY NOT APPLY IF WORK REGULATED BY SUCH CODES IS CLG - CEILING NOT WITHIN THE SCOPE OF THIS PROJECT. CLR - CLEAR - POWDER ACTUATED - CERAMIC MOSAIC (TILE FASTENER - CONCRETE MASONRY - PERIMETER PERF - PERFORATED - CLEAN OUT - PROPERTY LINE PLAM PLAS PLT PLWD COLUMN - PLASTIC LAMINATE CONCRETE - PLASTER CONTINUOUS or - PLATE CONTINUE - PLYWOOD PNL CONSTRUCTION **GENERAL NOTES** - POINT OF CONNECTION POC CLEAN OUT THRU - CLEAN OUT TO GRADE PTDF - PRESERVATIVE - CLEAN OUT THRU WALL TREATED DOUGLAS FIR COTW PTN COUNTERSINK - PARTITION CASEMENT PSL - PARALLEL STRAND - COUNTERSUNK SCREW LUMBER THE CONTRACTOR SHALL BECOME FAMILIAR WITH THE WORK PRIOR TO BID. CONTRACTOR SHALL VERIFY - POLYVINYL CHLORIDE COLD WATER EXISTING CONDITIONS AND DIMENSIONS AND SHALL REPORT ANY DISCREPANCIES OR UNIDENTIFIED CONDITIONS TO THE METROPOLITAN WATER DISTRICT FOR RESOLUTION BEFORE BEGINNING WORK. DRINKING FOUNTAIN - RELATIVE COMPACTION ANY DAMAGE TO EXISTING IMPROVEMENTS IN THE EXECUTION OF THE WORK IN THIS CONTRACT SHALL DIAMETER - ROOF DRAIN BE REPAIRED OR REPLACED BY THE CONTRACTOR AT NO ADDITIONAL COST TO THE METROPOLITAN REF DIAG - DIAGONAL - REFERENCE WATER DISTRICT OF SOUTHER CALIFORNIA. REFR REM REQ'D - REFRIGERATOR - DIMENSION DIVISION DO NOT SCALE THE DRAWINGS. CONTRACTOR SHALL FIELD VERIFY ALL DIMENSIONS. - DOOR - REQUIRED RES - DOWNSPOUT - RESILIENT DIMENSIONS, DETAILS, NOTES AND SYMBOLS THAT APPLY TO ONE UNIT, APPLY TO ALL UNITS IN LIKE - DRAWING REV - REVISION - REFLECT - ROUND HEAD WOOD UNLESS SPECIFICALLY SHOWN OR NOTED ON THE DRAWINGS, NO STRUCTURAL MEMBER SHALL BE CUT, - EXISTING SCREW NOTCHED, BORED OR OTHERWISE MODIFIED WITHOUT THE PERMISSION OF THE STRUCTURAL ENGINEER - EACH RDWD - REDWOOD OF RECORD. SEE MECHANICAL AND PLUMBING DRAWINGS FOR LOCATIONS OF FLOOR OR AREA DRAINS. - EXPANSION BOLT RWL - RAIN WATER LEADER LOUVERS, HEATING UNITS AND WET UTILITIES. - EXTERIOR INSULATION FINISHING SYSTEM - SCHEDULE INSTALLATION SHALL FOLLOW THE MANUFACTURER'S PUBLISHED SPECIFICATIONS AND/OR TRADE - EXPANSION JOINT - STORM DRAIN STANDARDS IN ADDITION TO MEETING OR EXCEEDING THE REFERENCED STANDARDS IDENTIFIED IN THE - ELEVATION · ELECTRICAL - SEE ELECTRICAL **EMERGENCY** DRAWINGS ALL PIPING AND CONDUIT SHALL BE LOCATED WITHIN WALLS AND AS HIGH AS POSSIBLE ABOVE - SQUARE FEET - ENCLOSURE (URE) CEILINGS. MECHANICAL, PLUMBING, AND ELECTRICAL DRAWINGS ARE DIAGRAMMATIC AND DO NOT SHOW - SHELF SHLV SHT EQUIPMENT - SHELVING - EXHAUST ALL DIMENSIONS ARE TO FACE OF STUD OR CENTERLINE OF COLUMN UNLESS NOTED OTHERWISE - EXPOSED - SHEATHING - EXTERIOR - SIMILAR THE CONTRACTOR SHALL NOTIFY THE METROPOLITAN WATER DISTRICT OF ANY DISCREPANCIES IN THE - SEE LANDSCAPE DOCUMENTS PRIOR TO PROCEEDING WITH ANY WORK INVOLVED. - FUTURE DRAWINGS - FABRICATION - SEE MECHANICAL 10. MATERIALS CONTAINING ASBESTOS ARE STRICTLY PROHIBITED FROM USE IN THIS PROJECT. - FACTORY DRAWINGS - SPECIFICATIONS - FURNISHED BY OTHERS 11. ALL WORK IS NEW UNLESS OTHERWISE NOTED. REVIEW EXISTING DRAWINGS AND SITE TO DETERMINE - FLOOR DRAIN - SQUARE WHAT SELECTIVE DEMOLITION MUST TAKE PLACE IN ORDER TO INSTALL NEW WORK. (SEE - FINISHED FLOOR - STAINLESS STEEL SPECIFICATIONS SECTION 02010) - FLAT HEAD MACHINE - SEE STRUCTURAL DRAWINGS 12. SF AREAS IF PROVIDED ON CONTRACT DOCUMENTS ARE NOT FOR BIDDING PURPOSES. CONTRACTOR TO - FLAT HEAD WOOD STN - STAIN DO HIS OWN TAKEOFFS. SCREW STD - STANDARD REFERENCES TO ANY DETAIL OR DRAWINGS IS FOR CONVENIENCE ONLY AND DOES NOT LIMIT THE - FLOOR JOIST - SELF TAPPING SHEET APPLICATION OF SUCH DETAIL OR DRAWINGS. DIMENSIONS AND CONDITIONS AT THE JOB SITE SHALL BE - FLOOR METAL SCREW VERIFIED BY THE CONTRACTOR. - FLUORESCENT - FOUNDATION THE CONTRACTOR SHALL PROVIDE THE NECESSARY BLOCKING, BACKING, FRAMING, HANGERS OR OTHER - FACE OF FINISH - TOP AND BOTTOM SUPPORT FOR ALL FIXTURES, EQUIPMENT, PIPING, CABINETRY, FURNISHINGS, WINDOW COVERINGS, - TELEPHONE - FACE OF PLYWOOD RAILINGS AND ALL OTHER ITEMS REQUIRING THE ABOVE. TEMP - TEMPERED SHEATHING T&G THRU - FACE OF STUD - TONGUE-AND-GROOVE THE CONTRACTOR SHALL INCLUDE IN THEIR BID ALL CORING, PATCHING AND REPAIRING REQUIRED FOR - FRAME (D), (ING) - THROUGH THE JOB, INCLUDING (BUT NOT LIMITED TO) STRUCTURAL ITEMS, MECHANICAL, ELECTRICAL AND - FIBERGLASS - TOOL JOINT TOC PLUMBING LINES, FIXTURE AND SITE WORK. REINFORCED PLASTIC - TOP OF CURB, CRICKET, PANELS 16. THE CONTRACTOR SHALL BE RESPONSIBLE FOR THE ACCURATE PLACEMENT OF WORK REQUIRED AS - FOOTING or CONCRETE PART OF THESE CONSTRUCTION DOCUMENTS. - FIRRED (ING) - TOP OF PARAPET - TOP OF SLAB, THE CONTRACTOR SHALL VERIFY THE EXACT LOCATIONS OF ALL EXISTING UTILITIES BEFORE SHEATHING, or STEEL COMMENCING WORK AND AGREES TO BE FULLY RESPONSIBLE FOR ANY AND ALL DAMAGES WHICH MIGHT - GYPSUM BOARD - TOILET PARTITION BE OCCASIONED BY THE CONTRACTOR'S FAILURE TO EXACTLY LOCATE AND PRESERVE ANY AND ALL GALVANIZED IRON - TOP OF SHEATHING DAMAGES WHICH MIGHT BE OCCASIONED BY THE CONTRACTOR'S FAILURE TO EXACTLY LOCATE AND - TOP SET BASE PRESERVE ANY AND ALL UNDERGROUND UTILITIES. - GLASS or GLAZING - TELEVISION TYP TWS - GALVANIZED - TYPICAL AREAS SUCH AS WALLS, DOORS AND FRAMES THAT ARE PART OR AFFECTED BY NEW WORK SHALL BE - GALVANIZED SHEET - TACKABLE WALL THOROUGHLY CLEANED AND PREPARED TO RECEIVE NEW PAINT IN ACCORDANCE WITH SPECIFICATION SYSTEM SECTION 09900. - GYPSUM - UNLESS OTHERWISE UON 19. "PROVIDE" = "FURNISH AND INSTALL" - HOSE BIBB NOTED - HARDWOOD - VARIES HEXAGONA - HOLLOW METAL - VAPOR BARRIER (STEEL) VCT - VINYL COMPOSITION - HORIZONTAL HOR - VINYL COVERED - HEATING VENTILATING TACKBOARD AIR CONDITIONING - VERTICAL - HOT WATER - VERIFY - VERTICAL GRAIN - INSIDE DIAMETER - VERIFY IN FIELD - INCLUDE (D), (ING) - VENT OVER or OFFSET - INSTRUCTION (S) - VENT RISER - INSULATE (D), (ION) VTR - VENT THROUGH ROOF - INTERIOR VWC - VINYL WALL COVERING - INVERT - WITH - JOIST - WOOD - JOINT - WIDE FLANGE - WOODWORK INSTITUTE - LAMINATE (D) - WINDOW - LAVATORY - WITH OUT - LAG BOLT - WHERE OCCURS - LOUVER - WOOD SCREW - LAY-IN CEILING PANEL - WAINSCOT PROJECT DESCRIPTION - MASONRY - MATERIAL - DIAMETER - PLUS/MINUS - MAXIMUM - MACHINE BOLT - DEGREES - CENTER LINE THE FOLLOWING IS A BRIEF DESCRIPTION OF THE SCOPE OF WORK. CONTRACTOR SHALL DETERMINE/VERIFY THE ENTIRE SCOPE AS SHOWN ON THE DRAWINGS AND SPECIFICATIONS PRIOR TO SUBMITTING BIDS. PHYSICAL SECURITY IMPROVEMENTS AT THE MWD HEADQUARTERS BUILDING. THE SCOPE OF THE **SYMBOLS LEGEND** PROJECT INCLUDES THE INSTALLATION OF NEW BOLLARDS AROUND THE PERIMETER OF THE SITE AND THE INSTALLATIONS OF AN ORNAMENTAL FENCE AT THE NORTH, NORTHEAST AND SOUTHWEST PORTIONS OF THE SITE. ROOM NAME ROOM NUMBER 101 --- S.F. ROOM AREA (101A)- DOOR NUMBER DEMOLITION SCHEDULE TAG ---- WINDOW NUMBER - ROOM NUMBER 101 ROOM NAME 1 A 1 CEILING SCHEDULE INDICATES DEMOLITION REQUIREMENTS. REFER TO DEMOLITION SCHEDULE AND BUILDING WALL TYPE FLOOR/BASE_DEMOLITION PLANS ACCESSORY TAG EXTERIOR ELEVATION REFERENCE

● 8'-0" CEILING HEIGHT TAG

WD HT CABINET HEIGHT

DETAIL NUMBER -

101-1

✓ INTERIOR ELEVATION NUMBER

SHEET NUMBER

- SHEET NUMBER

 AUXILIARY INTERIOR ELEVATION NUMBER

CLOCKWISE SEQUENCE

 KEYNOTE REFERENCE OR COLOR DESIGNATION

— CABINET DESIGNATION

ATTACHMENT C Design Plan

SHEET INDEX

GENERAL G0000 COVER SHEET G1000 **GENERAL NOTES** ARCHITECTURAL SITE DEMOLITON PLAN A1000 SITE PLAN A1100 SITE ENLARGED PLAN - ORNAMENTAL FENCE **ENLARGED SITE PLANS - PHYSICAL SECURITY ENLARGED SITE PLANS - PHYSICAL SECURITY DETAILS** A8001 A8002 **DETAILS**

Grand total: 9

IBI GROUP
1001 Wilshire Boulevard, Suite 100-3100,
Los Angeles, CA 90017, USA
tel 213 769 0011 fax 213 769 0016
ibigroup.com

COPYRIGHT

This drawing has been prepared solely for the intended use, thus any reproduction or distribution for any purpose other than authorized by IBI Group is forbidden. Written dimensions shall have precedence over scaled dimensions. Contractors shall verify and be responsible for all dimensions and conditions on the job, and IBI Group shall be informed of any variations from the dimensions and conditions shown on the drawing. Shop drawings shall be submitted to IBI Group for general conformance before proceeding with fabrication.

IBI Group, A California Partnership

CONSULTANT:

STATE SEAL:



PROJECT
HEADQUARTERS
BUILDING
EXTERIOR
PHYSICAL
SECURITY
IMPROVEMENTS

SPECIFICATION NO.: 2003
PROJECT NUMBER: 105168
DRAWING NUMBER:
APPROVAL SHEET NO.:

ADDRESS: 700 N. ALAMEDA ST. LOS ANGELES, CA 90012

REVISIONS:

DELTA TITLE DATE BY

50% CHECKSET MARCH 2021 IBI

PM: GENERAL

PE:

SENIOR TECH. MGR.:

DRAWN BY: AO

SCALE: 12" = 1'-0"

DATE: 04/22/21


JOB NO.: 116535

JOB NO.: 116535
SHEET TITLE.:

GENERAL NOTES

SHEET NO.:

G1000

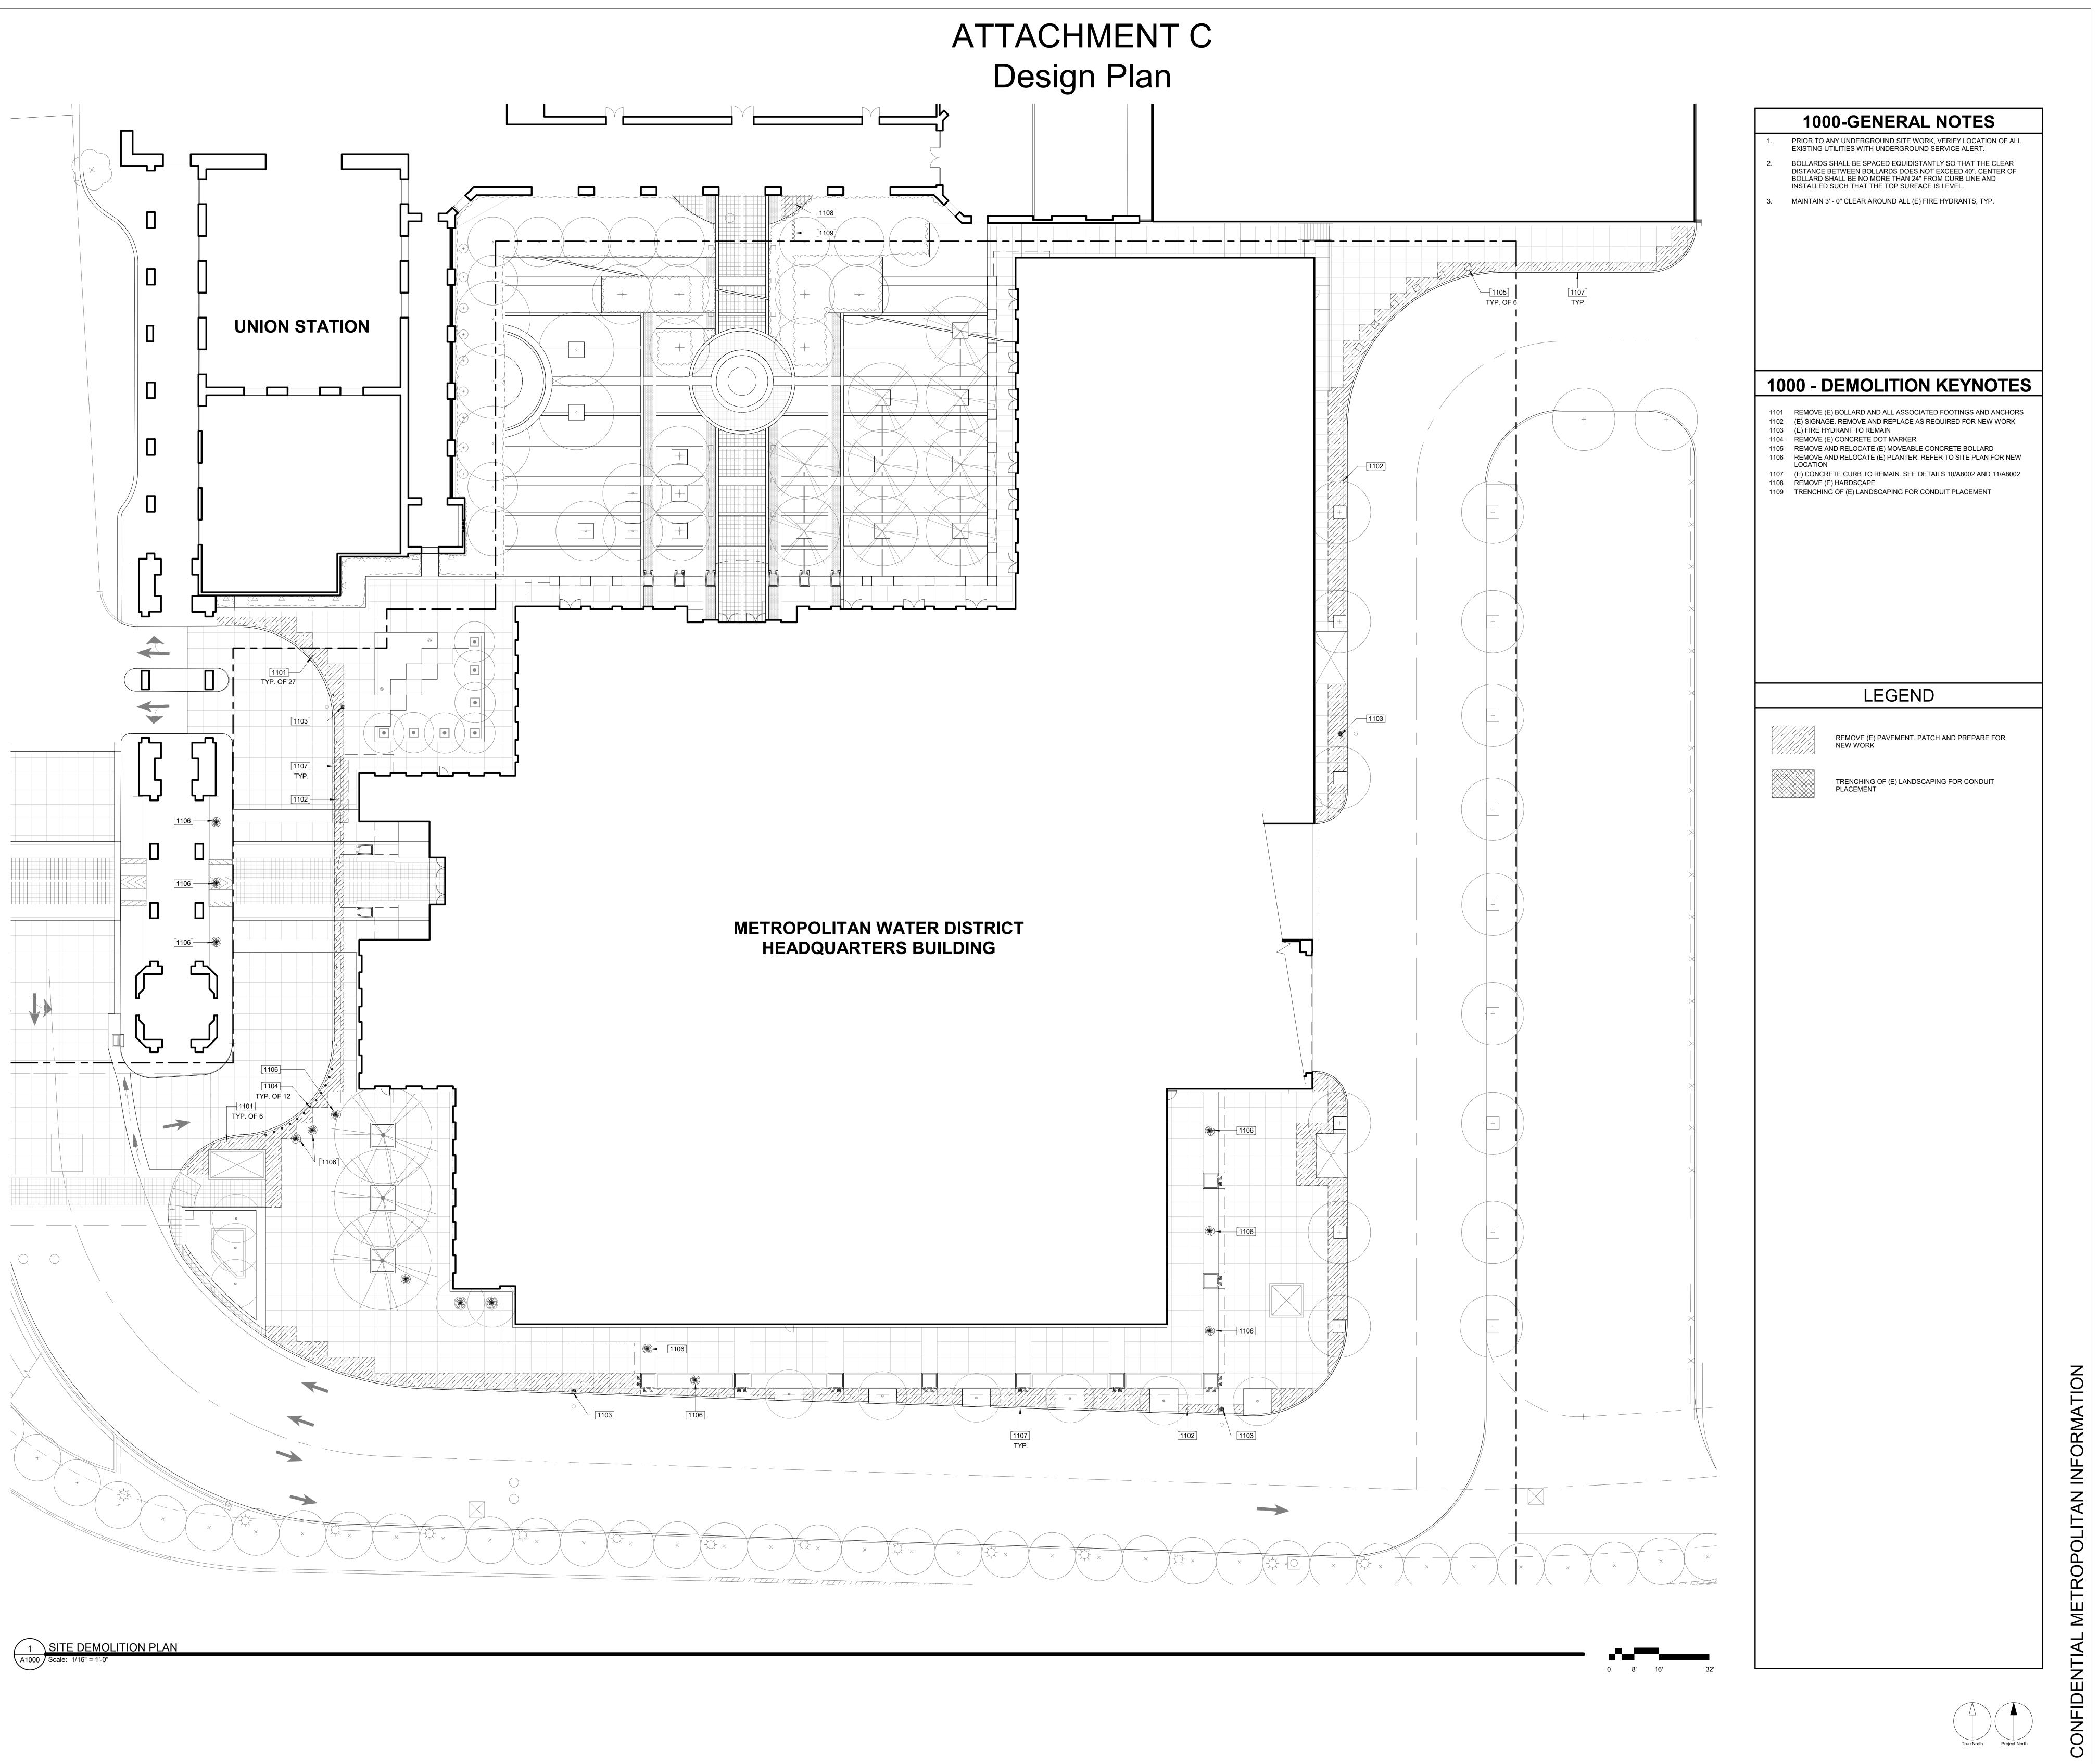

Los Angeles, CA 90017, USA tel 213 769 0011 fax 213 769 0016 ibigroup.com

PYRIGHT
s drawing has been prepared solely for the intended use, thus any reproduction or distribution for any purpose other than authorized by IBI Group is forbidden.

COPYRIGHT

This drawing has been prepared solely for the intended use, thus any reproduction or distribution for any purpose other than authorized by IBI Group is forbidden. Written dimensions shall have precedence over scaled dimensions. Contractors shall verify and be responsible for all dimensions and conditions on the job, and IBI Group shall be informed of any variations from the dimensions and conditions shown on the drawing. Shop drawings shall be submitted to IBI Group for general conformance before proceeding with fabrication.

IBI Group, A California Partnership is a member of the IBI Group of companies

CONSULTANT:

STATE SEAL:

PROJECT
HEADQUARTERS
BUILDING
EXTERIOR
PHYSICAL
SECURITY
IMPROVEMENTS

SPECIFICATION NO.: 2003
PROJECT NUMBER: 105168
DRAWING NUMBER:
APPROVAL SHEET NO.:


ADDRESS: 700 N. ALAMEDA ST. LOS ANGELES, CA 90012

M: ARCHITECTU
E:
ENIOR TECH. MGR.:
PRAWN BY: AO
CALE: As indicated
DATE: 04/22/21
OB NO.: 116535

SITE DEMOLITON PLAN

SHEET NO.:

A1000

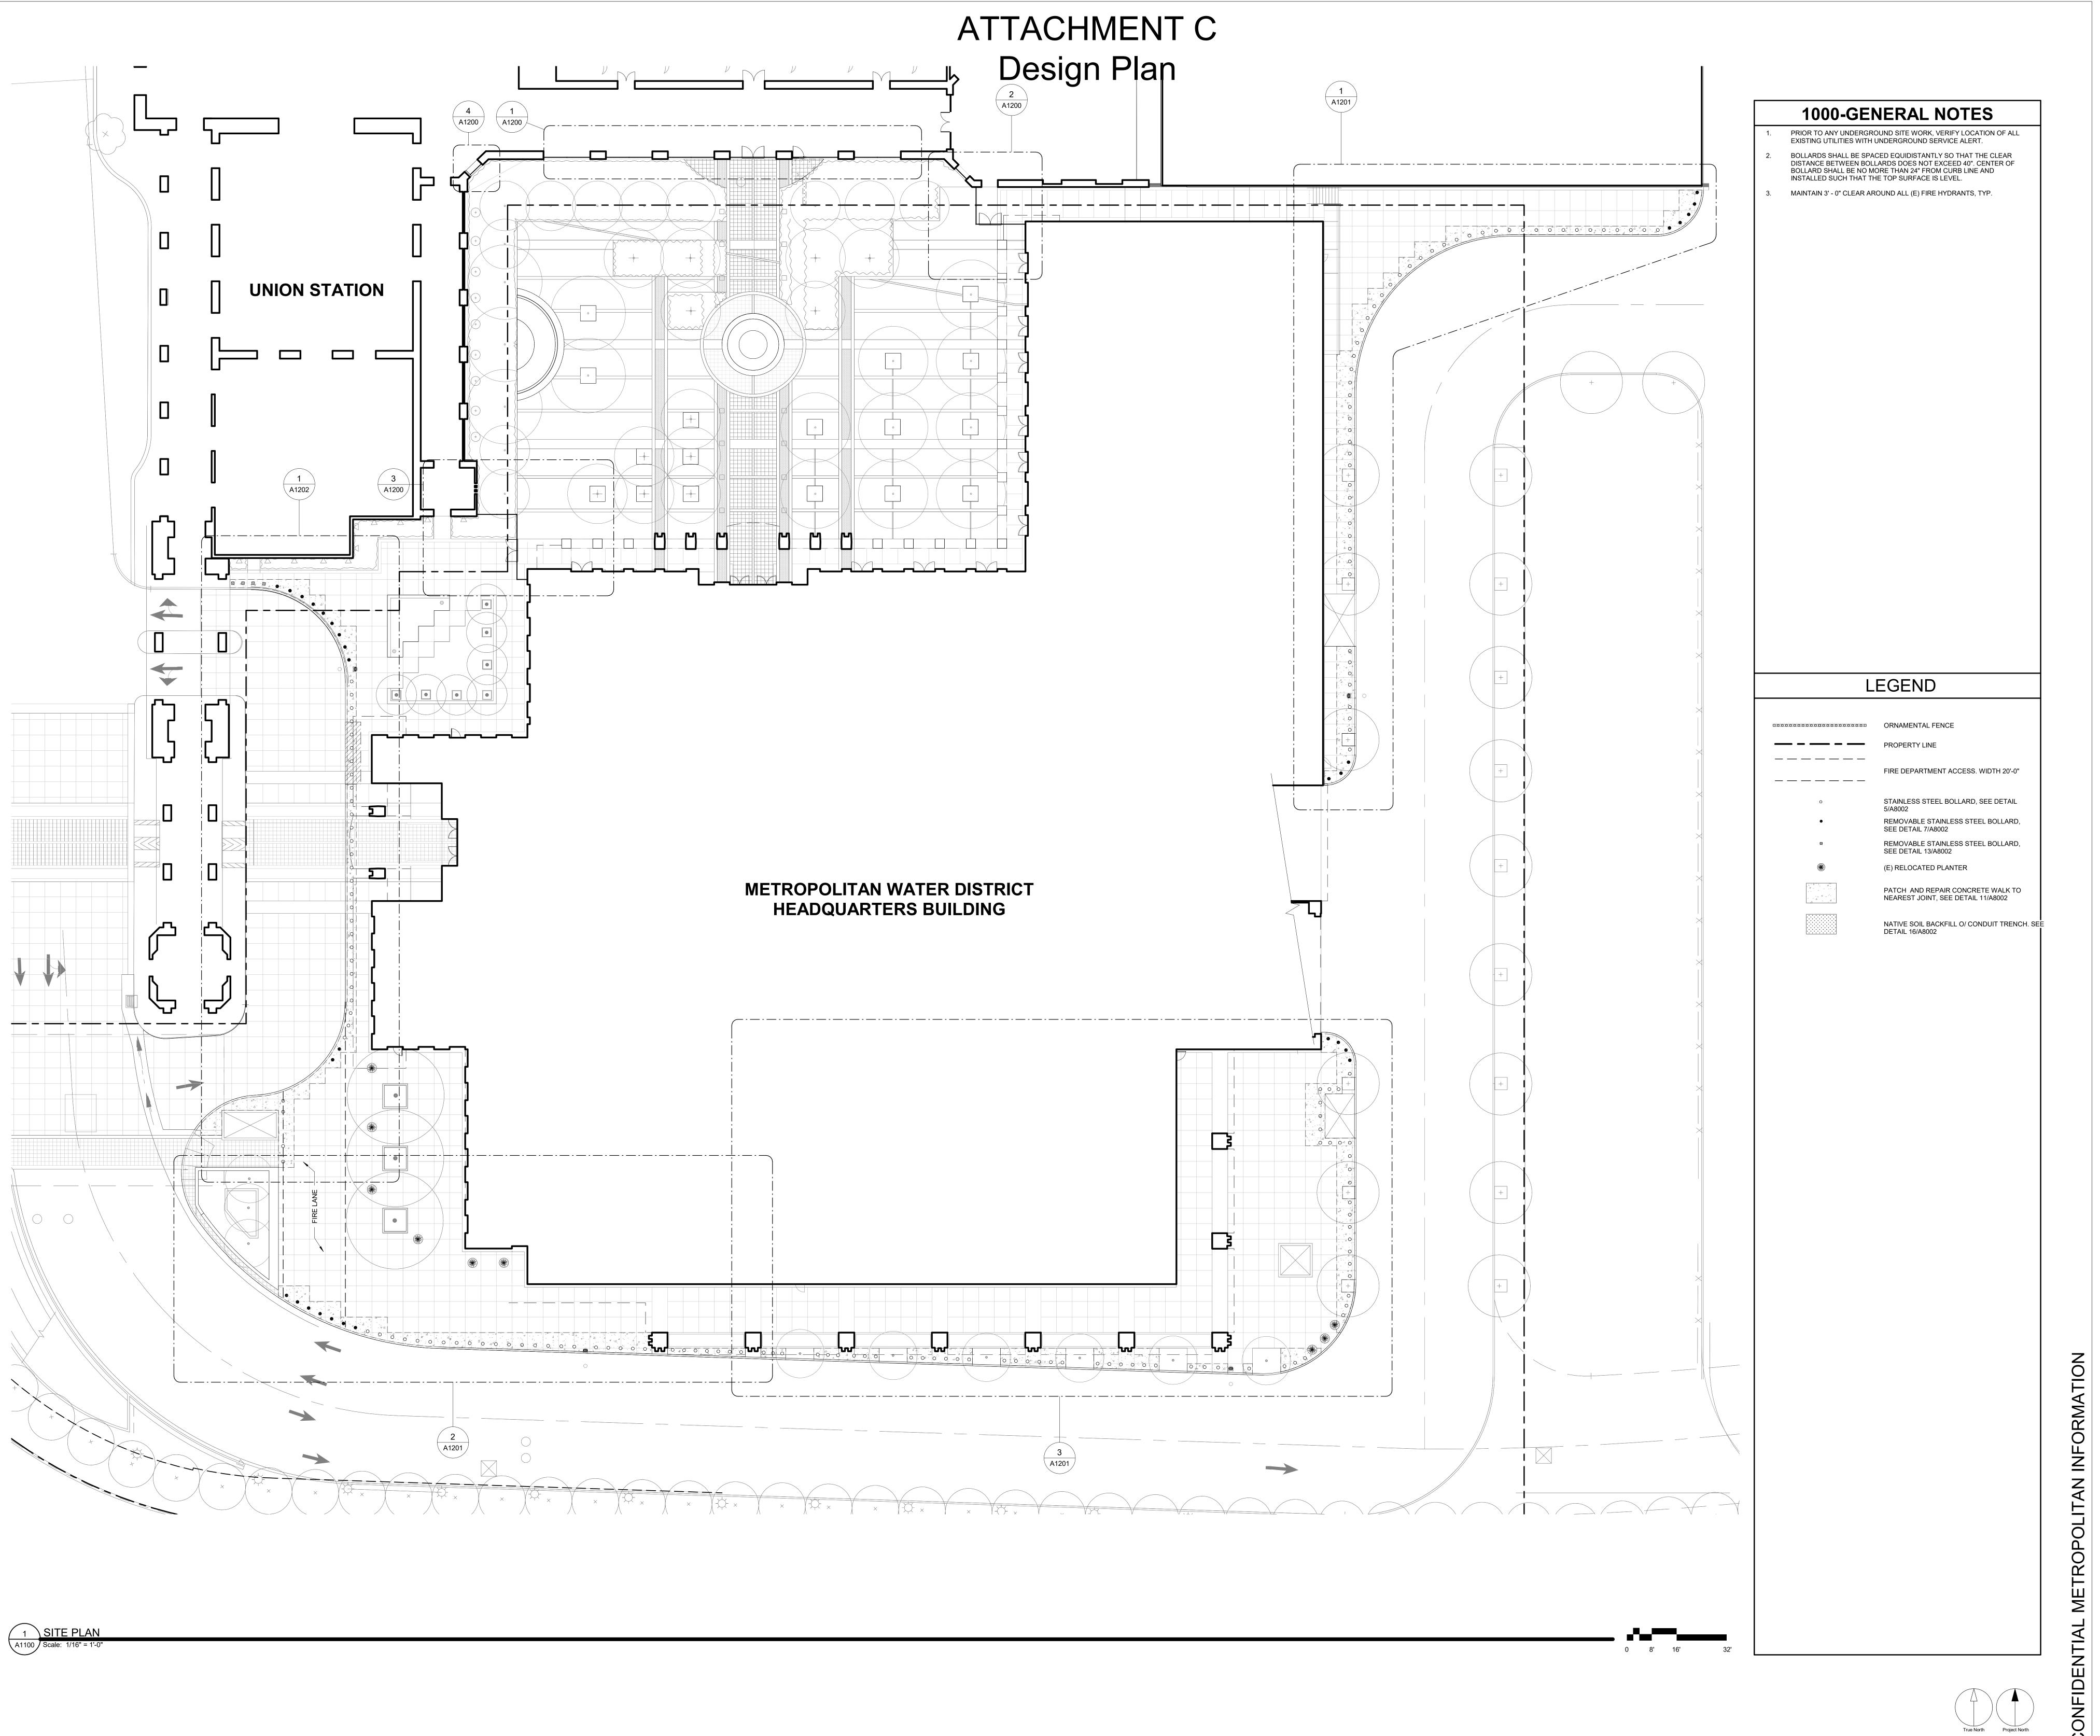

IBI GROUP
1001 Wilshire Boulevard, Suite 100-3100,
Los Angeles, CA 90017, USA
tel 213 769 0011 fax 213 769 0016
ibigroup.com

COPYRIGHT

This drawing has been prepared solely for the intended use, thus any reproduction or distribution for any purpose other than authorized by IBI Group is forbidden. Written dimensions shall have precedence over scaled dimensions. Contractors shall verify and be responsible for all dimensions and conditions on the job, and IBI Group shall be informed of any variations from the dimensions and conditions shown on the drawing. Shop drawings shall be submitted to IBI Group for general conformance before proceeding with fabrication.

CONSULTANT:


STATE SEAL:

PROJECT HEADQUARTERS BUILDING EXTERIOR PHYSICAL SECURITY **IMPROVEMENTS**

SPECIFICATION NO.: PROJECT NUMBER: DRAWING NUMBER: APPROVAL SHEET NO.:

700 N. ALAMEDA ST. LOS ANGELES, CA 90012

DELTATITLEDATEBY50% CHECKSETMARCH 2021IBI

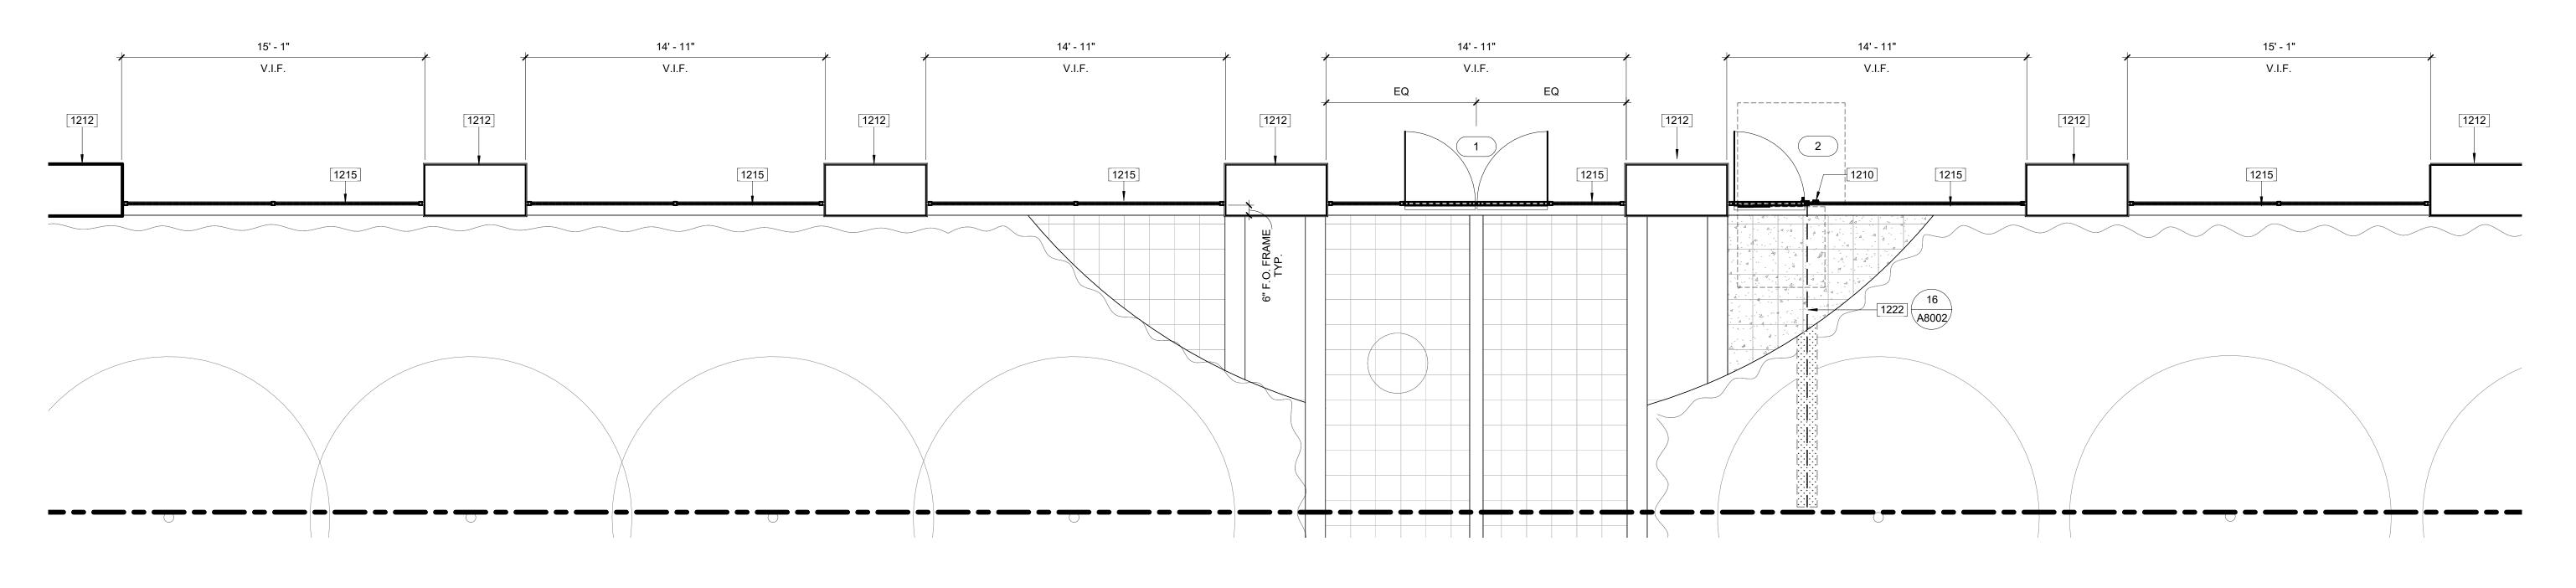

1000-GENERAL NOTES

PRIOR TO ANY UNDERGROUND SITE WORK, VERIFY LOCATION OF ALL EXISTING UTILITIES WITH UNDERGROUND SERVICE ALERT.
 BOLLARDS SHALL BE SPACED EQUIDISTANTLY SO THAT THE CLEAR DISTANCE BETWEEN BOLLARDS DOES NOT EXCEED 40% CENTER OF AUGUSTANCE DESCRIPTION.

2. BOLLARDS SHALL BE SPACED EQUIDISTANTLY SO THAT THE CLEAR DISTANCE BETWEEN BOLLARDS DOES NOT EXCEED 40". CENTER OF BOLLARD SHALL BE NO MORE THAN 24" FROM CURB LINE AND INSTALLED SUCH THAT THE TOP SURFACE IS LEVEL.

MAINTAIN 3' - 0" CLEAR AROUND ALL (E) FIRE HYDRANTS, TYP.

1100 - KEYNOTES

- 1210 CARD READER
 1212 (E) CONCRETE COLUMN WITH PLASTER FINISH. PATCH AND REPAIR FINISH AS NECESSARY FOR NEW WORK
- 1215 ORNAMENTAL FENCE PER DETAIL 6/A8001
 1216 ORNAMENTAL FENCE PER DETAIL 5/A8001
 1221 (E) CONCRETE WALL WITH PLASTER FINISH. PATCH AND REPAIR FINISH AS
- 1221 (E) CONCRETE WALL WITH PLASTER FINISH. PATCH AND REPAIR FII NECESSARY FOR NEW WORK 1222 ELECTRICAL CONDUIT

UNION STATION


1215

1216 TYP.


\ENLARGED SITE PLAN - ORNAMENTAL FENCE WEST


7' - 1"

7' - 9"

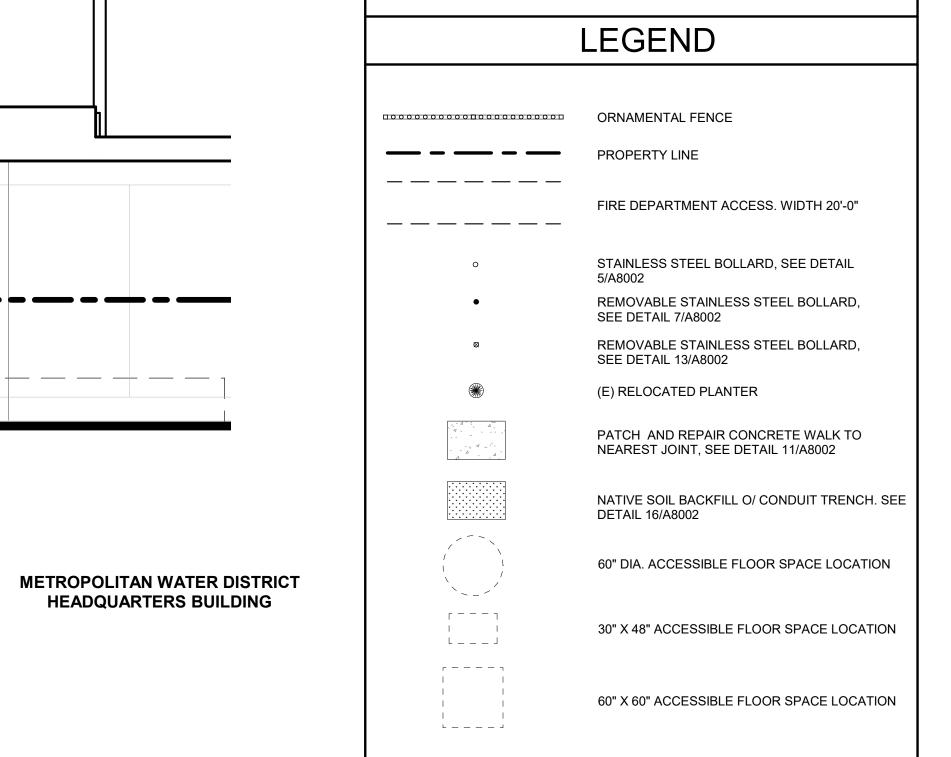

1 ENLARGED SITE PLAN - ORNAMENTAL FENCE NORTH		
A1200 Scale: 1/4" = 1'-0"		0 2' 4' 8'
	<u> </u>	

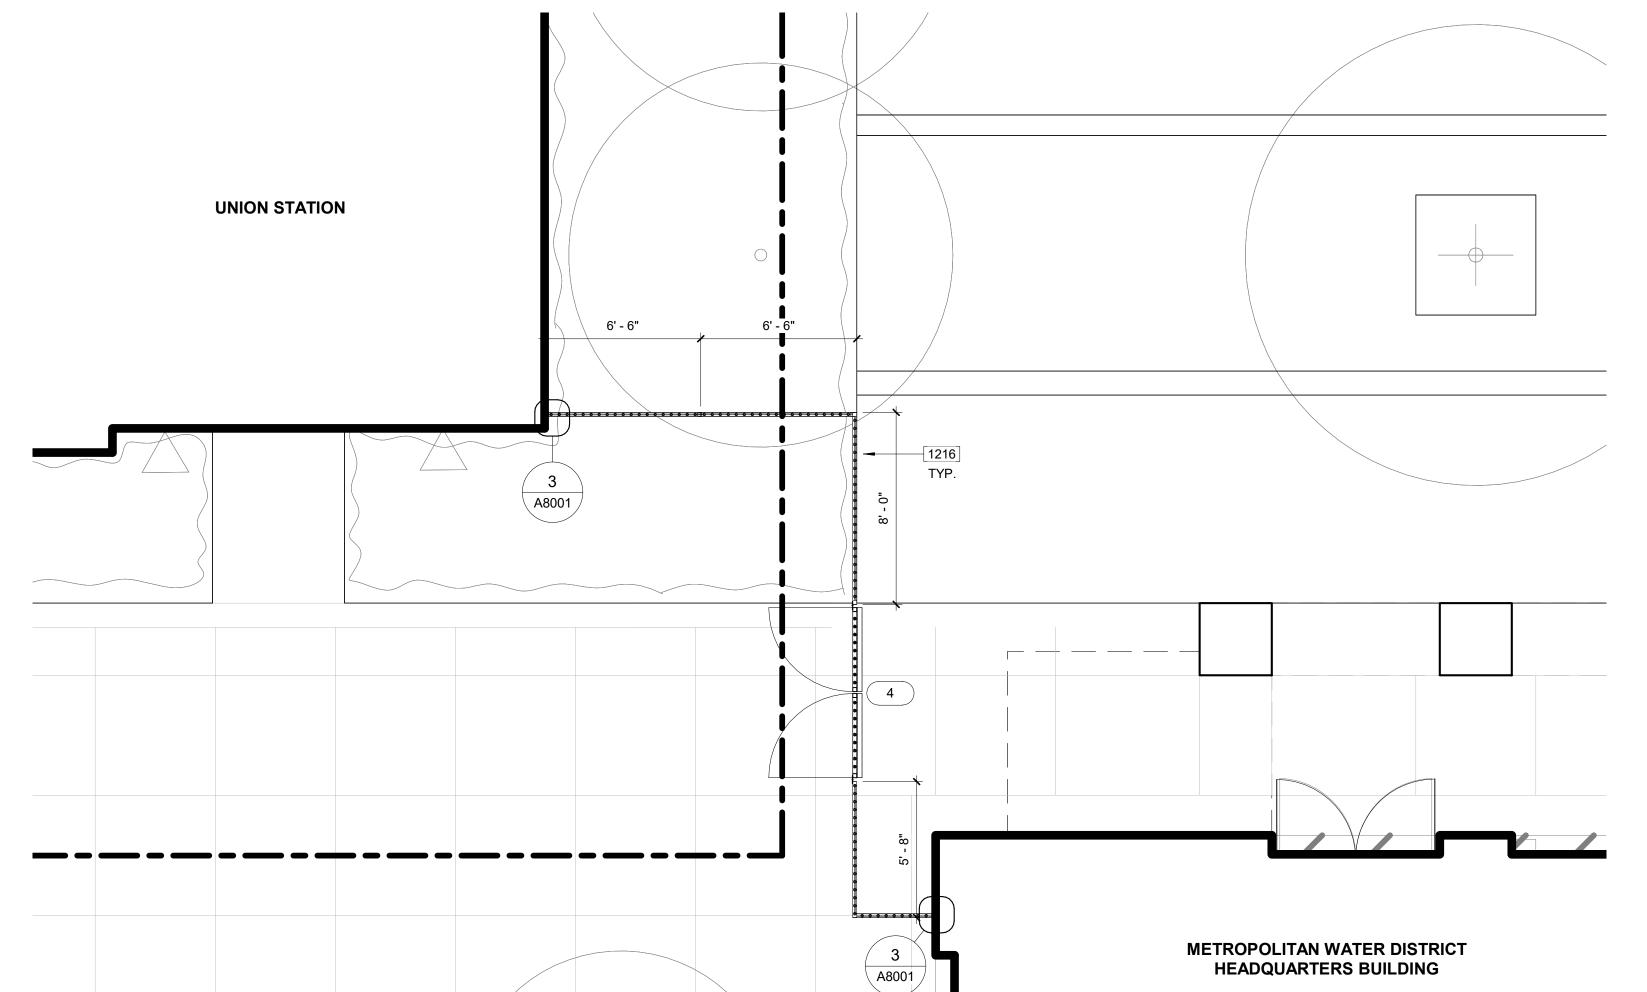

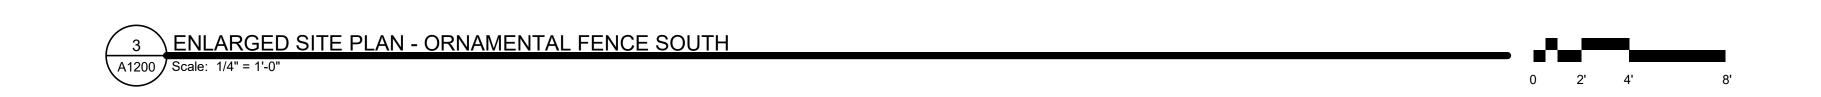

4 ENLARGED SITE PLAN - ORNAMENTAL FENCE NORTH WEST

					GATE SCH	HEDULE			
DOOR No. TY	YPE MAT	FINISH	WIDTH	HEIGHT HARDWARE	PANIC	SIGNAGE	DETAIL	REMARKS	DOOR No.
1 A	AA		7' - 0"	8' - 9"	Yes		18/A8001		1
2 B	BB		3' - 6"	8' - 4"	Yes		17/A8001		2
3 A	AA		7' - 0"	8' - 9"	Yes		18/A8001		3
4 A	AA		7' - 0"	8' - 9"	Yes		18/A8001		4

OLITAN INFORMATION

PM:	ARCHITECTURAL
PE:	
SENIOR TECH. N	MGR.:
DRAWN BY:	AO
SCALE:	As indicated
DATE:	04/22/21
JOB NO.:	116535
SHEET TITLE.:	

1001 Wilshire Boulevard, Suite 100-3100, Los Angeles, CA 90017, USA tel 213 769 0011 fax 213 769 0016 ibigroup.com

COPYRIGHT

This drawing has been prepared solely for the intended use, thus any reproduction or distribution for any purpose other than authorized by IBI Group is forbidden. Written dimensions shall have precedence over scaled dimensions. Contractors shall verify and be responsible for all dimensions and conditions on the job, and IBI Group shall be informed of any variations from the dimensions and conditions shown on the drawing. Shop drawings shall be submitted to IBI Group for general conformance before proceeding with fabrication.

IBI Group, A California Partnership is a member of the IBI Group of companies

CONSULTANT:

STATE SEAL:

PROJECT

BUILDING

EXTERIOR PHYSICAL

SECURITY

PROJECT NUMBER:

700 N. ALAMEDA ST. LOS ANGELES, CA 90012

DRAWING NUMBER: APPROVAL SHEET NO.:

HEADQUARTERS

IMPROVEMENTS

DELTATITLEDATEBY50% CHECKSETMARCH 2021IBI


SPECIFICATION NO.: 2003

SHEET NO.:

A1200

True North Project North

C.\Users\alejandra.orellana\Documents\REVIT2020\116535_MWD-ExtPhysicalSecurityImprov_V2020_alejandra.orellana.rv

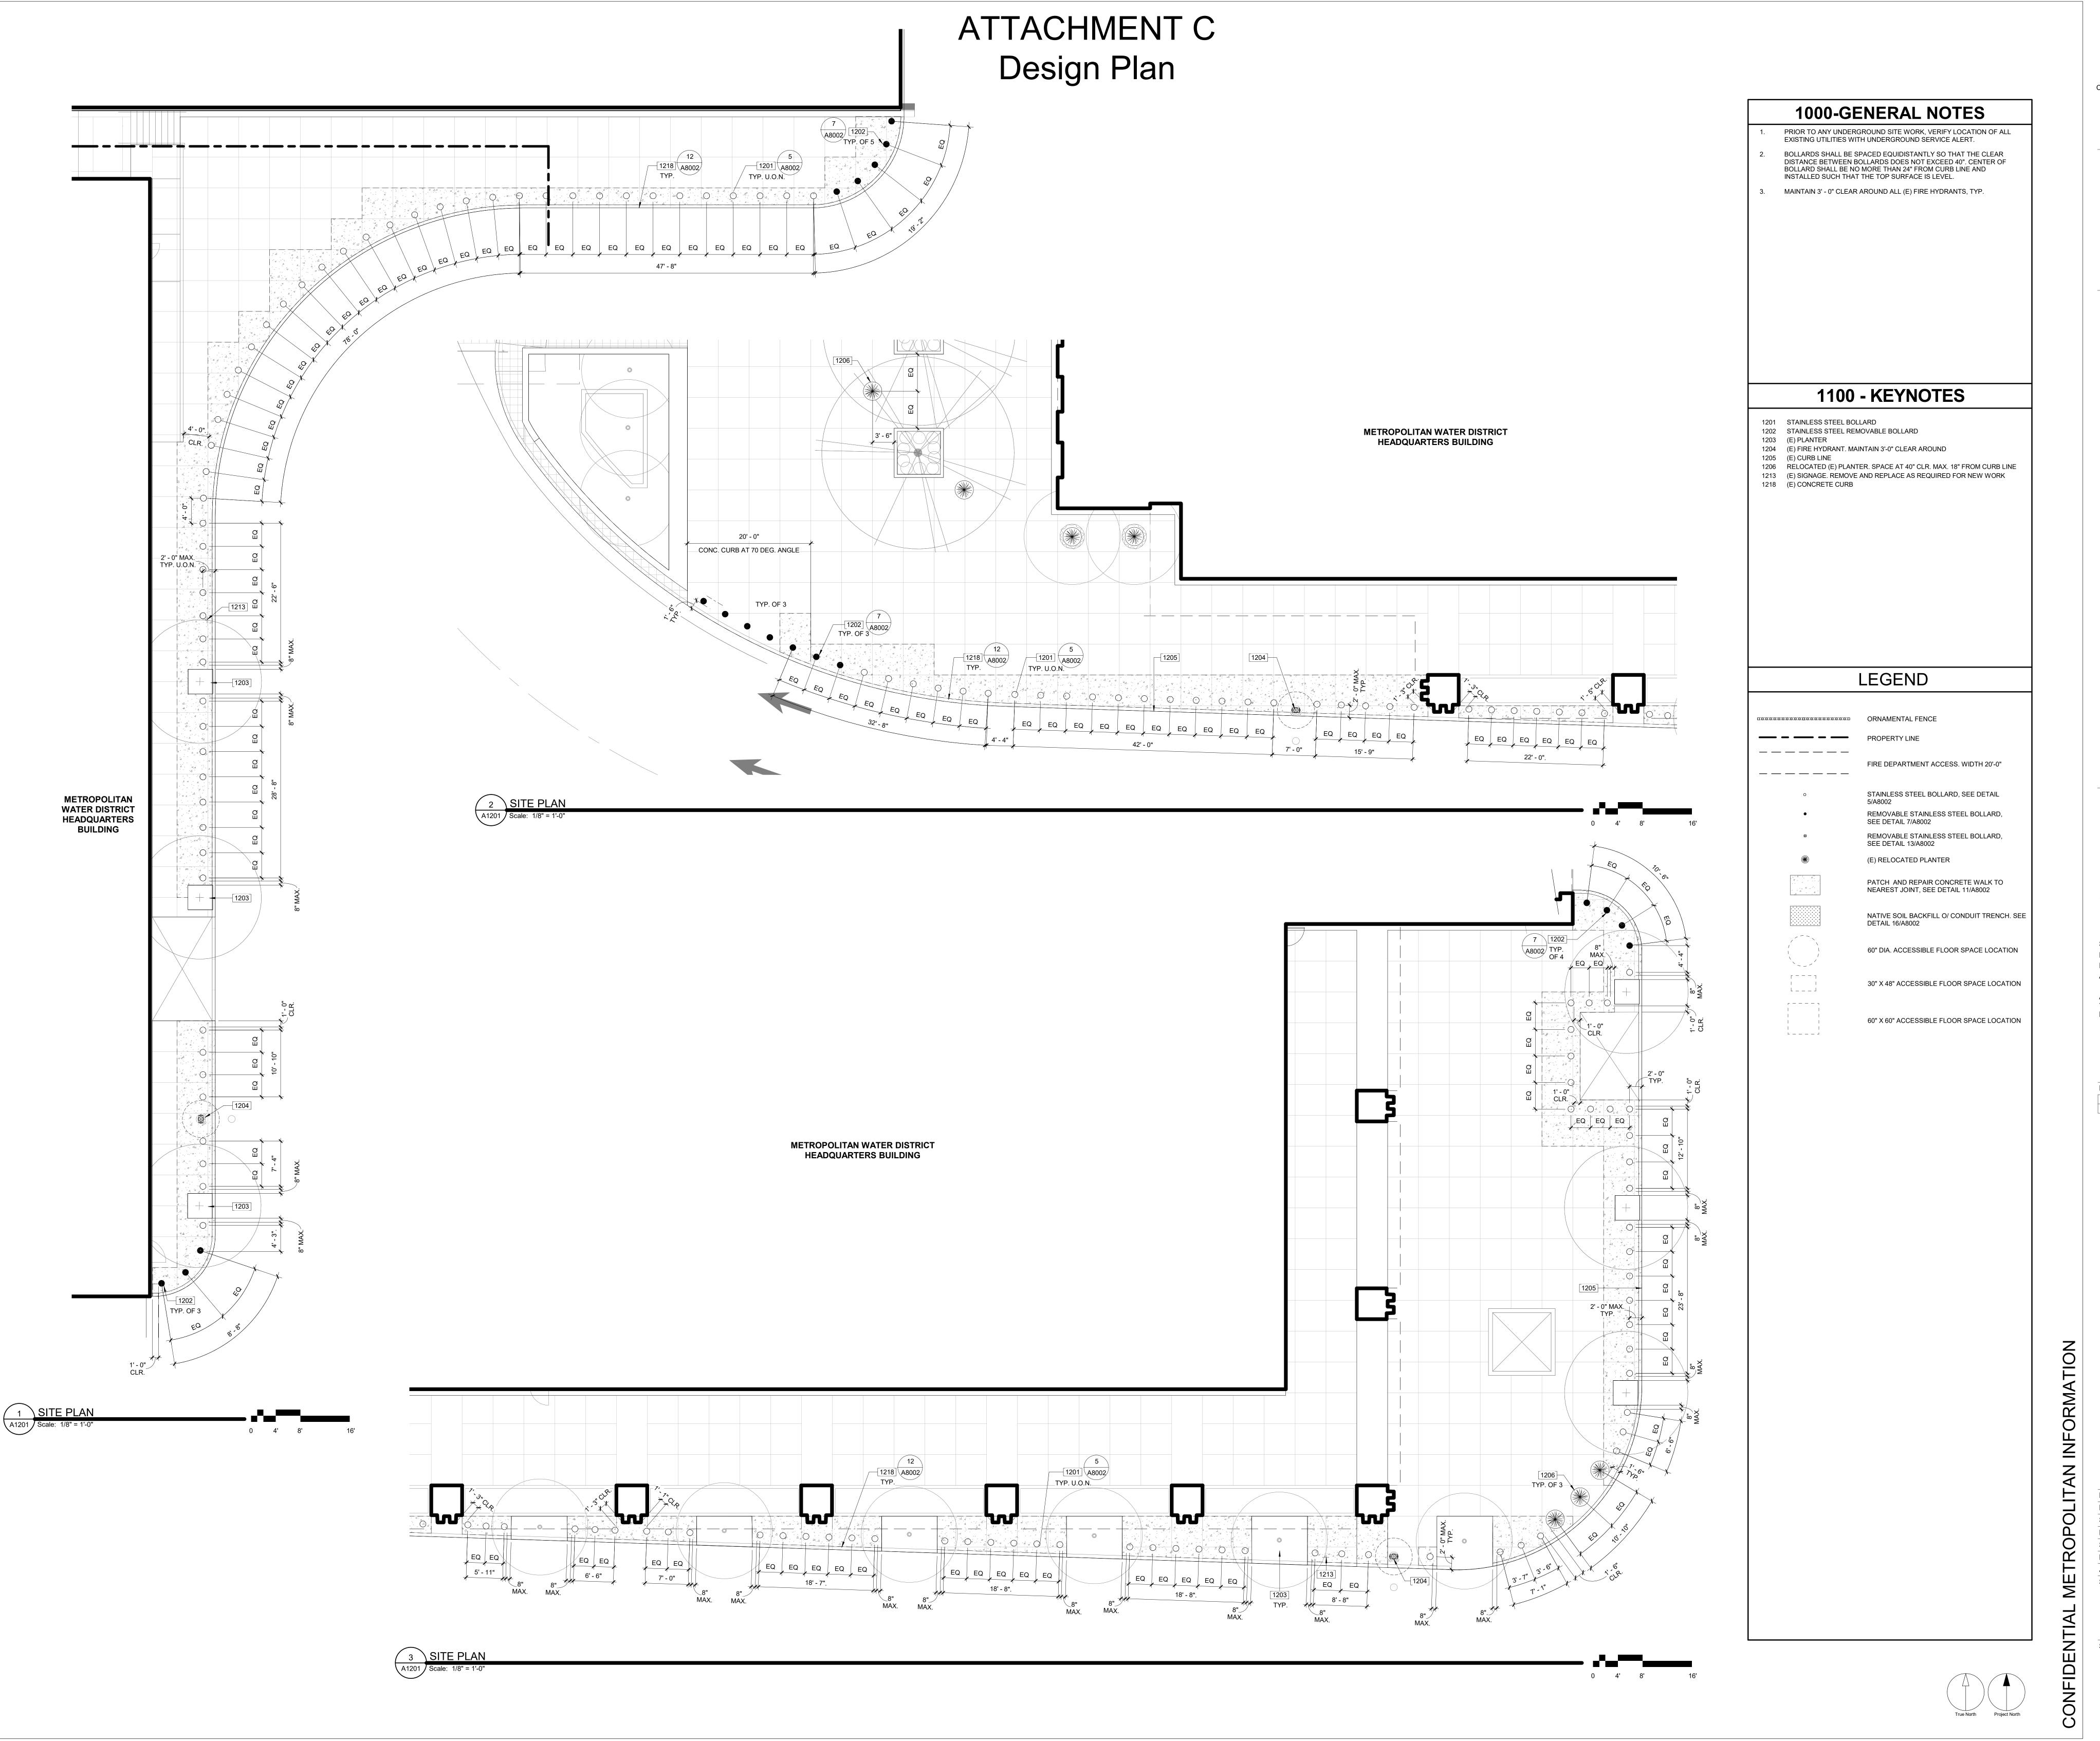

IBI GROUP
1001 Wilshire Boulevard, Suite 100-3100,
Los Angeles, CA 90017, USA
tel 213 769 0011 fax 213 769 0016
ibigroup.com

COPYRIGHT

This drawing has been prepared solely for the intended use, thus any reproduction or distribution for any purpose other than authorized by IBI Group is forbidden. Written dimensions shall have precedence over scaled dimensions. Contractors shall verify and be responsible for all dimensions and conditions on the job, and IBI Group shall be informed of any variations from the dimensions and conditions shown on the drawing. Shop drawings shall be submitted to IBI Group for general conformance before proceeding with fabrication.

IBI Group, A California Partnership is a member of the IBI Group of companies

CONSULTANT:

STATE SEAL:

A SOLION OF CHICAGO SOLION OF

PROJECT
HEADQUARTERS
BUILDING
EXTERIOR
PHYSICAL
SECURITY
IMPROVEMENTS


SPECIFICATION NO.: 2003
PROJECT NUMBER: 105168
DRAWING NUMBER:
APPROVAL SHEET NO.:

ADDRESS: 700 N. ALAMEDA ST. LOS ANGELES, CA 90012

OR TECH. MGR.:
VN BY:
E:
IO.:
T TITLE.:

PHYSICAL SECURITY

A1201

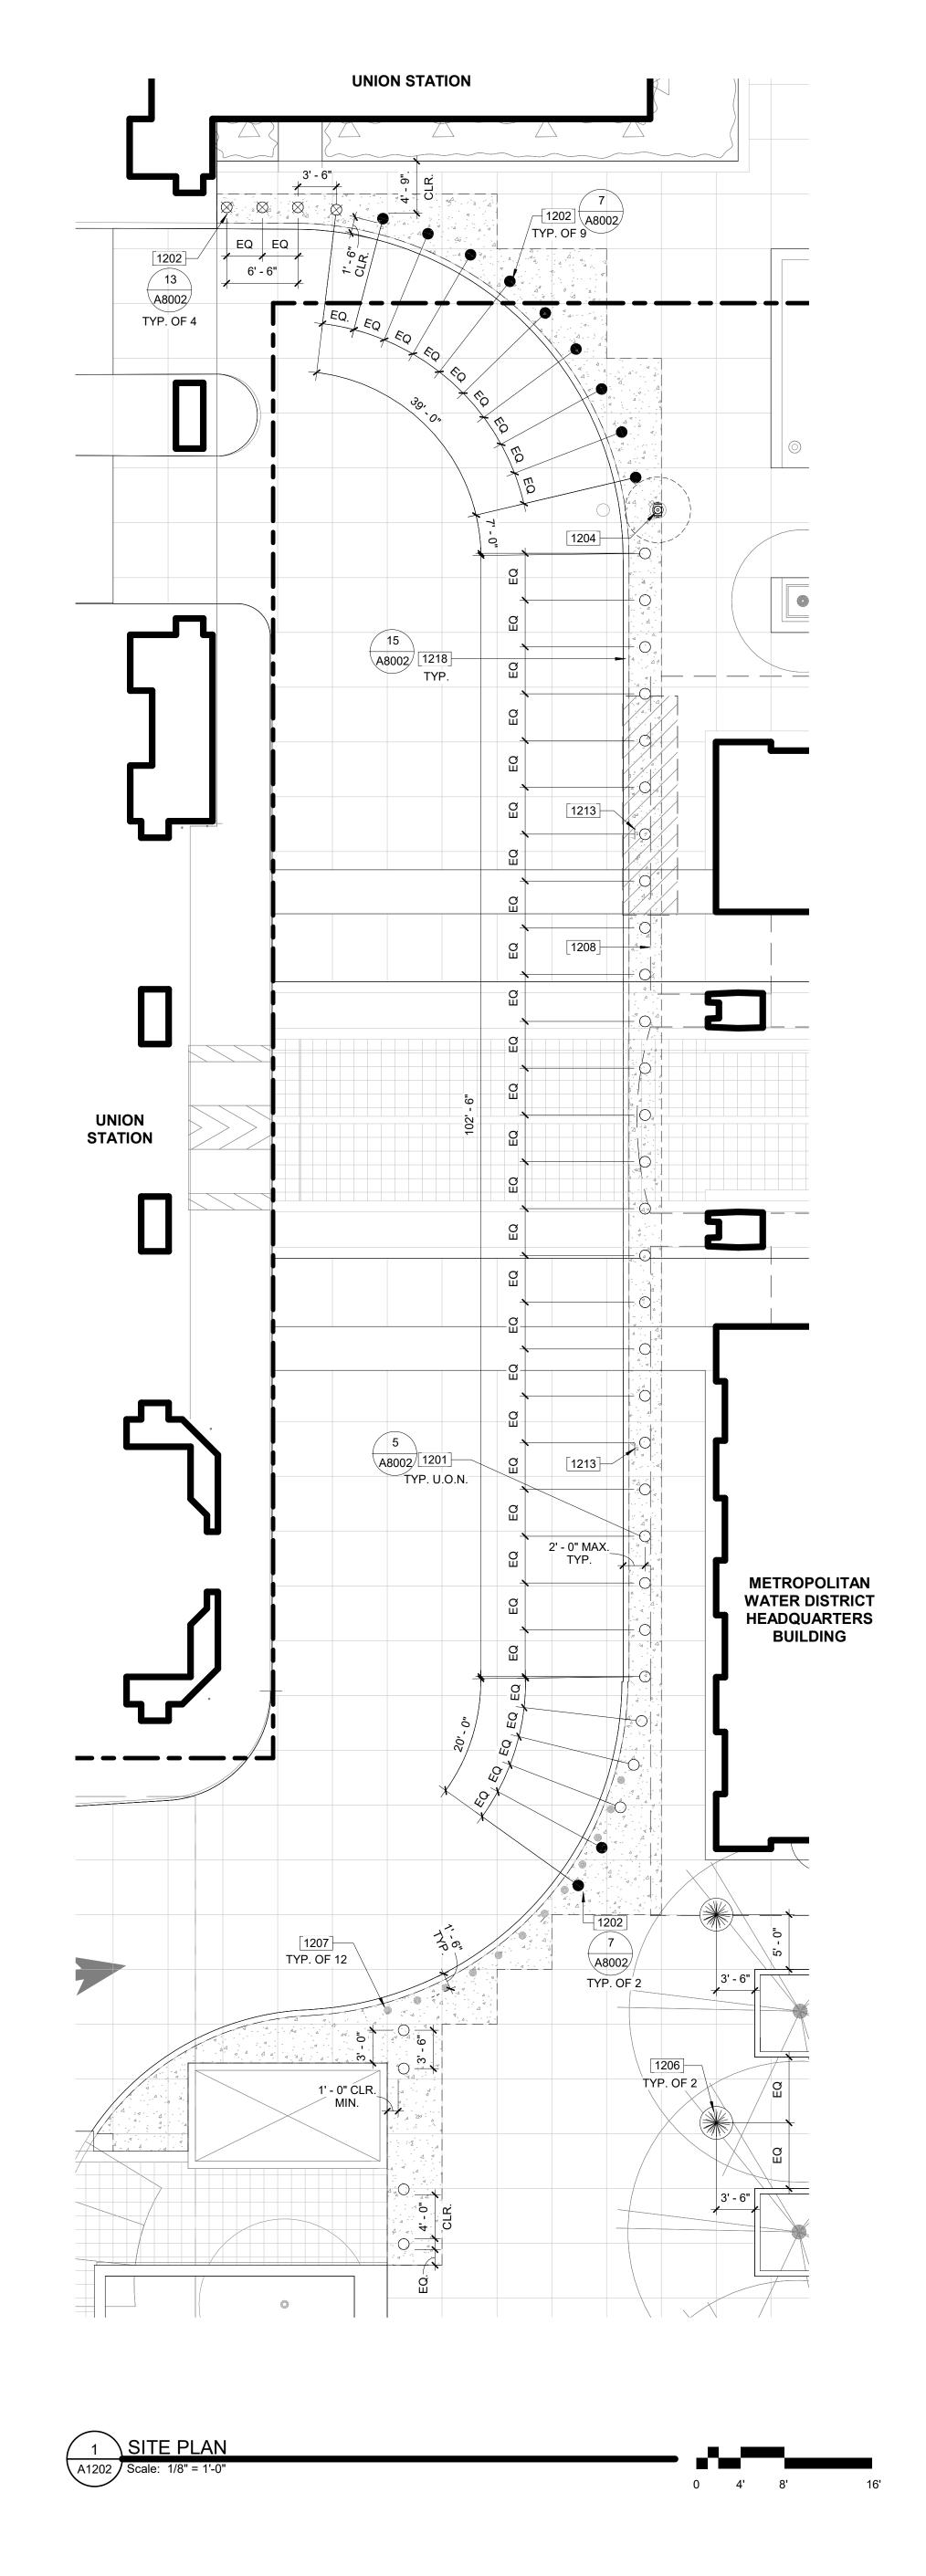



PRIOR TO ANY UNDERGROUND SITE WORK, VERIFY LOCATION OF ALL EXISTING UTILITIES WITH UNDERGROUND SERVICE ALERT. BOLLARDS SHALL BE SPACED EQUIDISTANTLY SO THAT THE CLEAR DISTANCE BETWEEN BOLLARDS DOES NOT EXCEED 40". CENTER OF BOLLARD SHALL BE NO MORE THAN 24" FROM CURB LINE AND INSTALLED SUCH THAT THE TOP SURFACE IS LEVEL.

MAINTAIN 3' - 0" CLEAR AROUND ALL (E) FIRE HYDRANTS, TYP.

1100 - KEYNOTES

1201 STAINLESS STEEL BOLLARD 1202 STAINLESS STEEL REMOVABLE BOLLARD

1204 (E) FIRE HYDRANT. MAINTAIN 3'-0" CLEAR AROUND 1206 RELOCATED (E) PLANTER. SPACE AT 40" CLR. MAX. 18" FROM CURB LINE 1207 (E) LANE MARKER 1208 (E) CANOPY ABOVE

1213 (E) SIGNAGE. REMOVE AND REPLACE AS REQUIRED FOR NEW WORK 1218 (E) CONCRETE CURB

LEGEND

ORNAMENTAL FENCE _ _ _ _ _ _ _ _ FIRE DEPARTMENT ACCESS. WIDTH 20'-0" _____ STAINLESS STEEL BOLLARD, SEE DETAIL REMOVABLE STAINLESS STEEL BOLLARD, SEE DETAIL 7/A8002 REMOVABLE STAINLESS STEEL BOLLARD, SEE DETAIL 13/A8002 (E) RELOCATED PLANTER

PATCH AND REPAIR CONCRETE WALK TO NEAREST JOINT, SEE DETAIL 11/A8002 NATIVE SOIL BACKFILL O/ CONDUIT TRENCH. SEE DETAIL 16/A8002 60" DIA. ACCESSIBLE FLOOR SPACE LOCATION

> 30" X 48" ACCESSIBLE FLOOR SPACE LOCATION ADDRESS: 700 N. ALAMEDA ST. LOS ANGELES, CA 90012 60" X 60" ACCESSIBLE FLOOR SPACE LOCATION

PROJECT

EXTERIOR

PHYSICAL

SECURITY

DRAWING NUMBER: APPROVAL SHEET NO.:

HEADQUARTERS

IMPROVEMENTS

SPECIFICATION NO.: 2003

PROJECT NUMBER: 105168

DELTA TITLE DATE BY 50% CHECKSET MARCH 2021 IBI

181 GROUP 1001 Wilshire Boulevard, Suite 100-3100, Los Angeles, CA 90017, USA tel 213 769 0011 fax 213 769 0016 ibigroup.com

COPYRIGHT

This drawing has been prepared solely for the intended use, thus any reproduction or distribution for any purpose other than authorized by IBI Group is forbidden. Written dimensions shall have precedence over scaled dimensions. Contractors shall verify and be responsible for all dimensions and conditions on the job, and IBI Group shall be informed of any variations from the dimensions and conditions shown on the drawing. Shop drawings shall be submitted to IBI Group for general conformance before proceeding with fabrication.

IBI Group, A California Partnership is a member of the IBI Group of companies


CONSULTANT:

STATE SEAL:

ARCHITECTURAL

ENLARGED SITE PLANS -PHYSICAL SECURITY

A1202

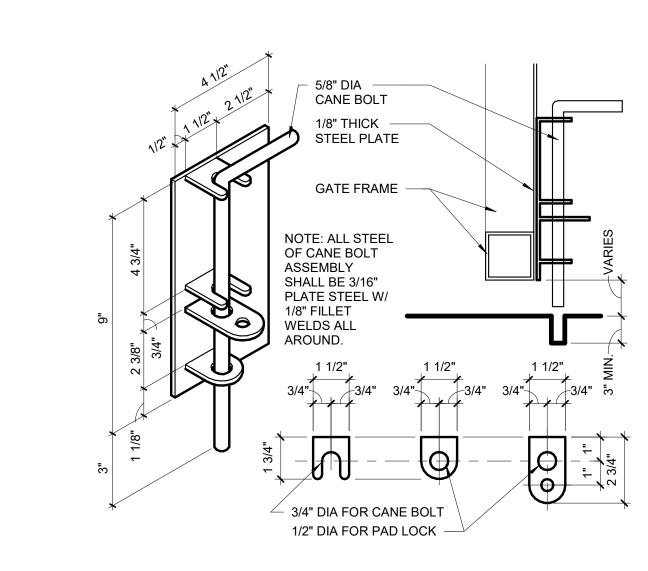




181 GROUP 1001 Wilshire Boulevard, Suite 100-3100, Los Angeles, CA 90017, USA tel 213 769 0011 fax 213 769 0016 ibigroup.com

CONSULTANT:


STATE SEAL:



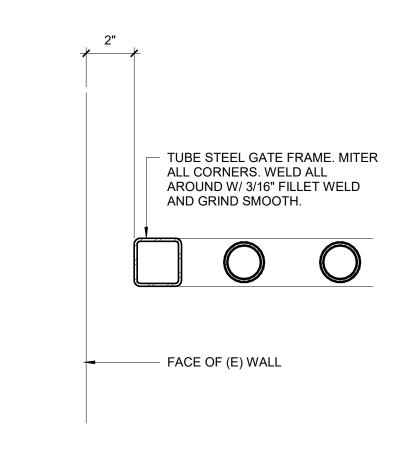



ORNAMENTAL FENCE FRAME @ WALL

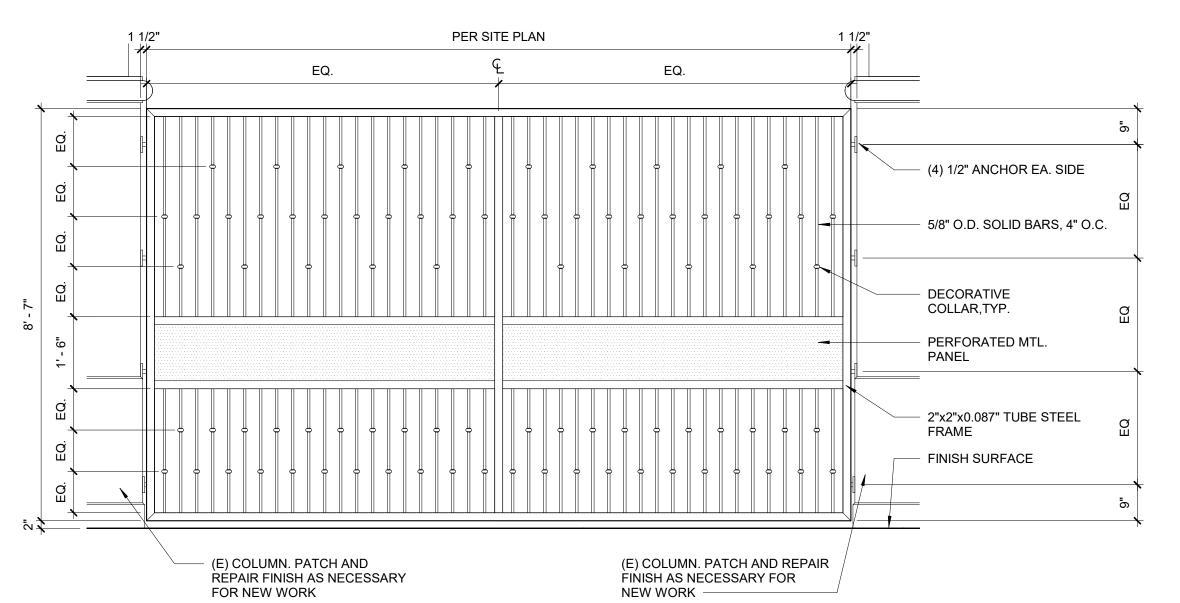


BUILDING EXTERIOR PHYSICAL SECURITY **IMPROVEMENTS** SPECIFICATION NO.: 2003 PROJECT NUMBER: DRAWING NUMBER: APPROVAL SHEET NO.: ADDRESS: 700 N. ALAMEDA ST. LOS ANGELES, CA 90012

HEADQUARTERS

PROJECT

DELTATITLEDATEBY50% CHECKSETMARCH 2021IBI


6 TYP. ORNAMENTAL FENCE ELEVATION AT ARCADE

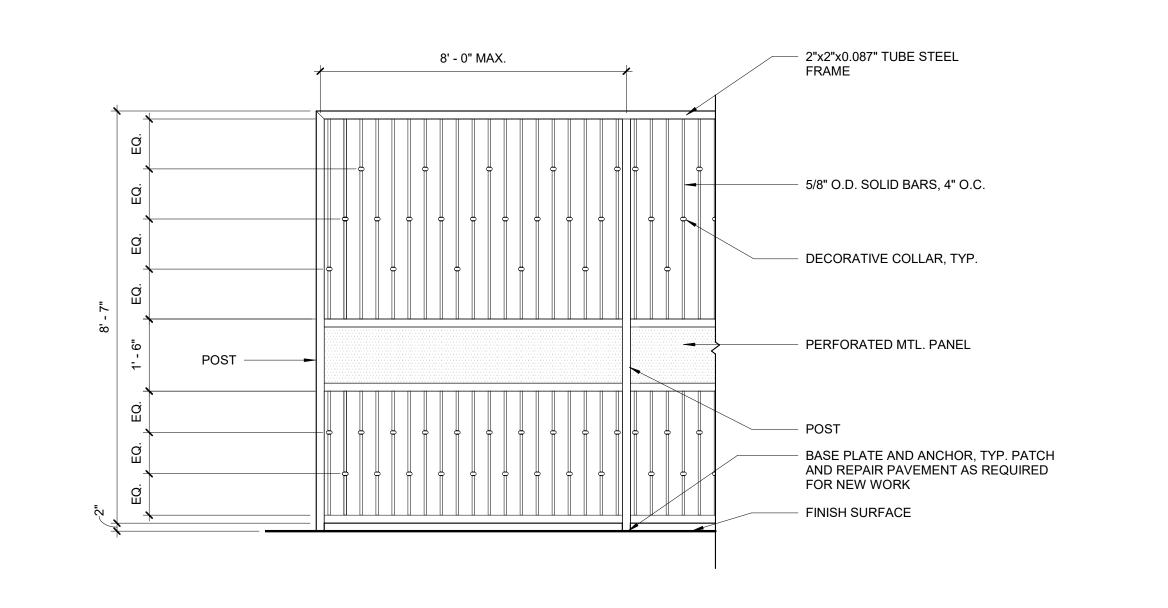


ARCHITECTURAL SENIOR TECH. MGR.: DRAWN BY: As indicated 04/22/21 116535 JOB NO.: SHEET TITLE .:


SHEET NO.:


TYP. ORNAMENTAL FENCE ELEVATION A8001

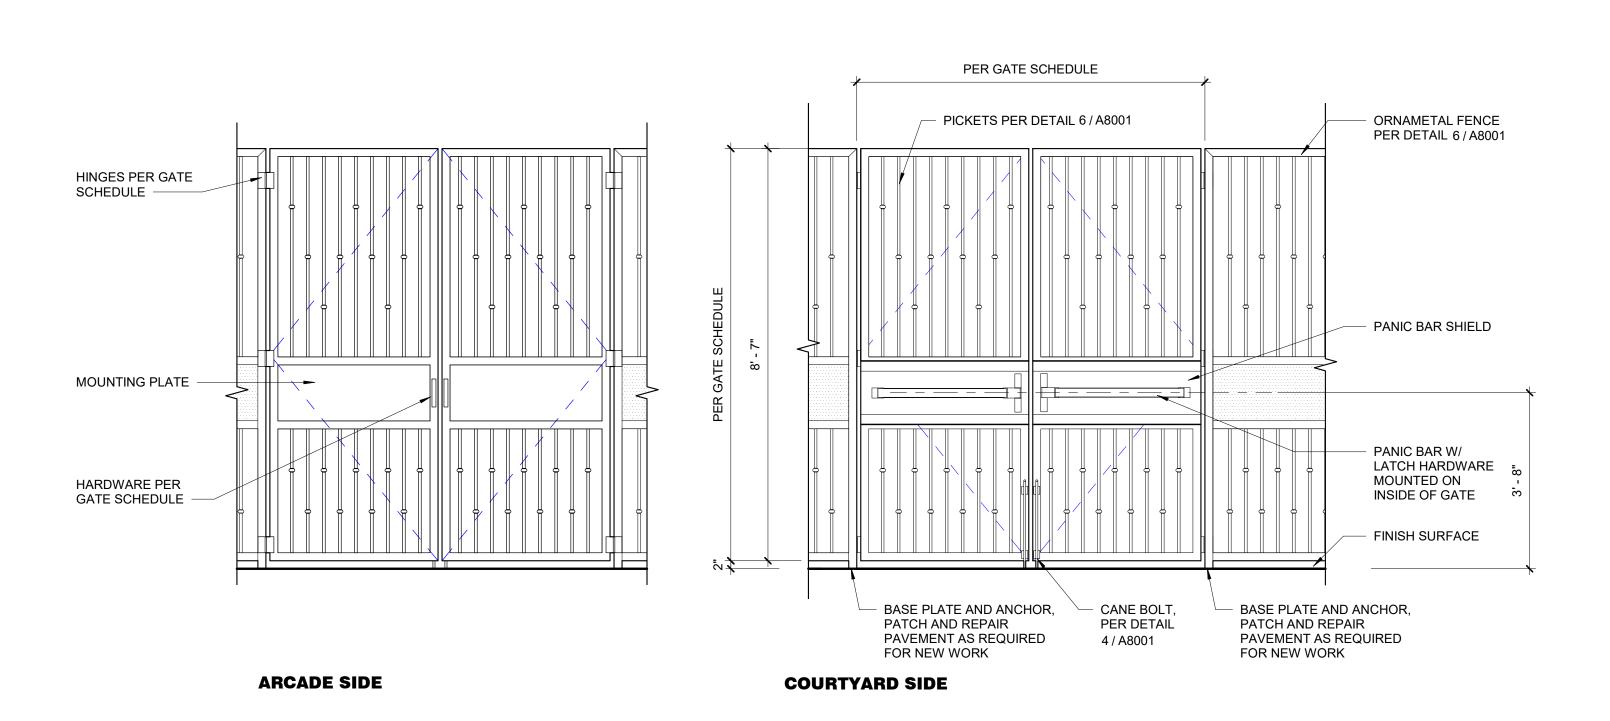




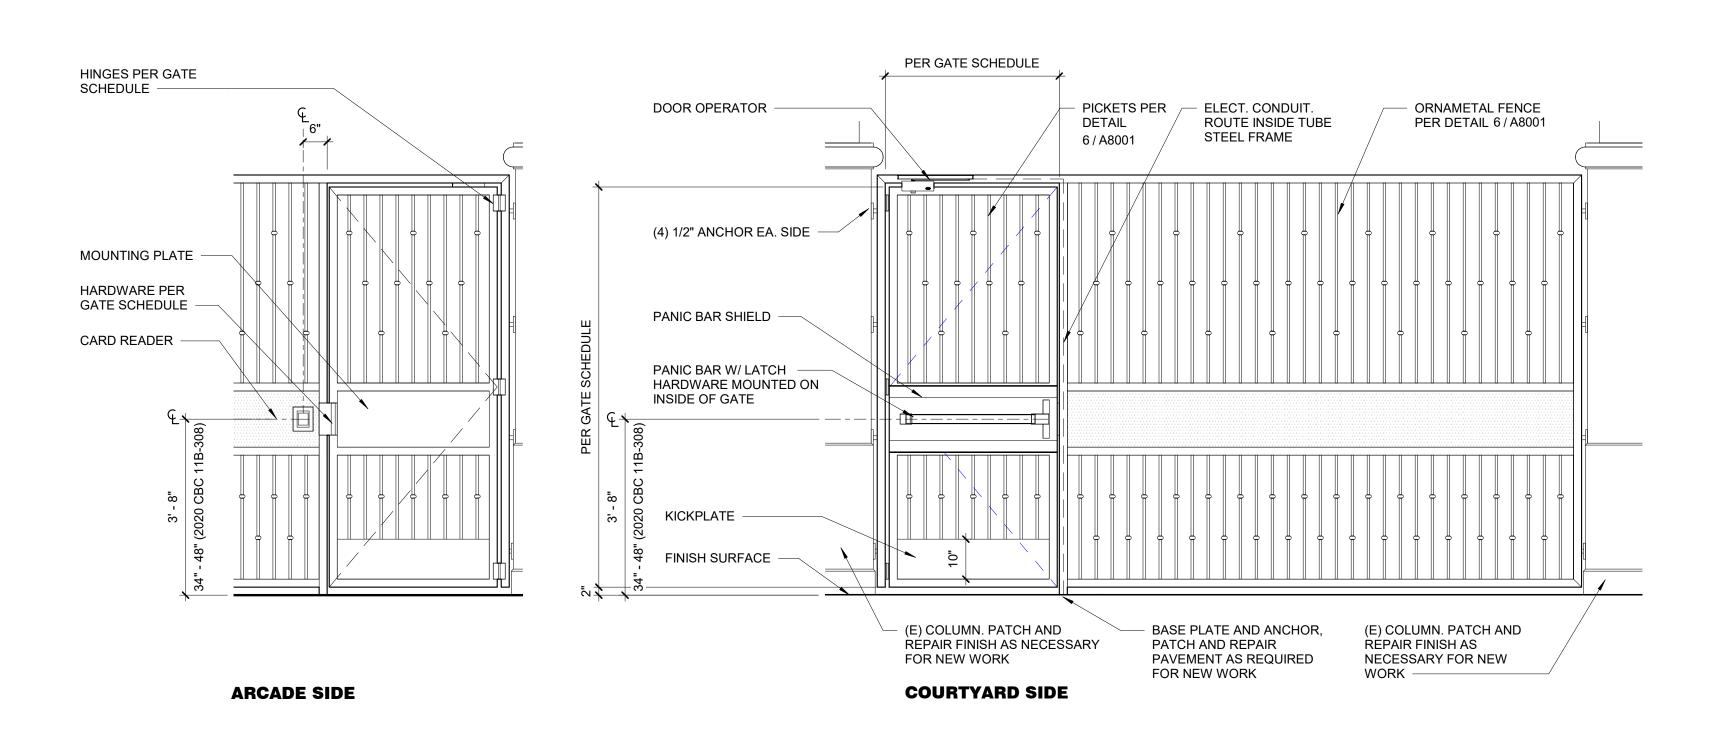

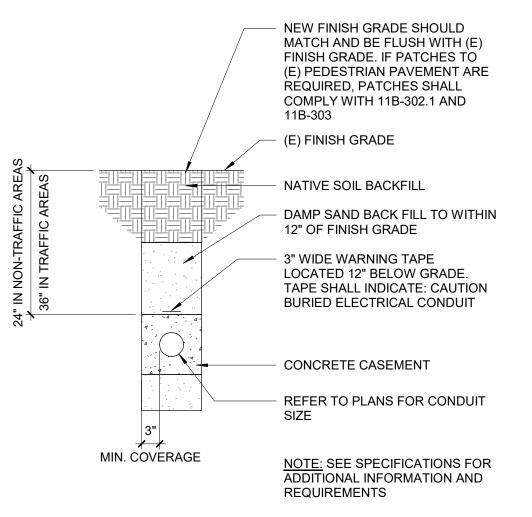

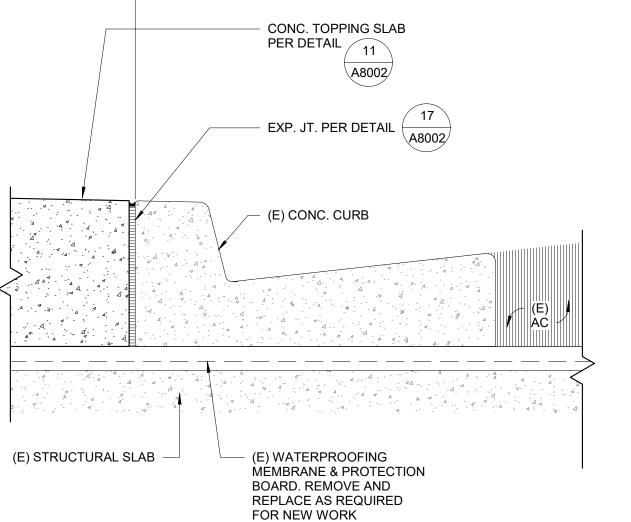

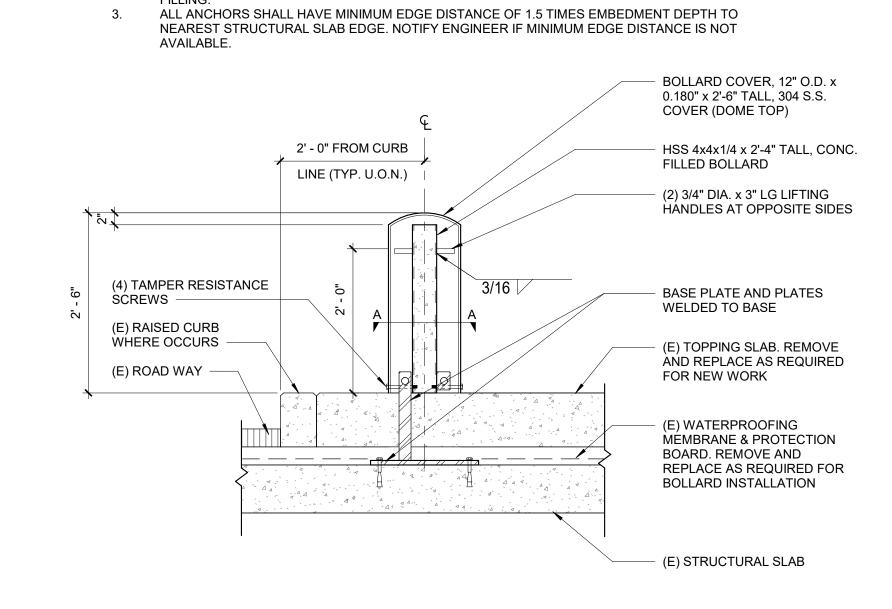



1. BOLLARD COVER MANUFACTURER SHALL PROVIDE INTERNAL FRAMEWORK. BETWEEN COVER AND HSS TO MAINTAIN POSITION OF COVER DURING NORMAL DAY-TO-DAY OPERATIONS.

HOT-DIPPED GALVANIZED BASE PLATE ASSEMBLY AND HSS4X4 ASSENBLY PRIOR TO CONCRETE





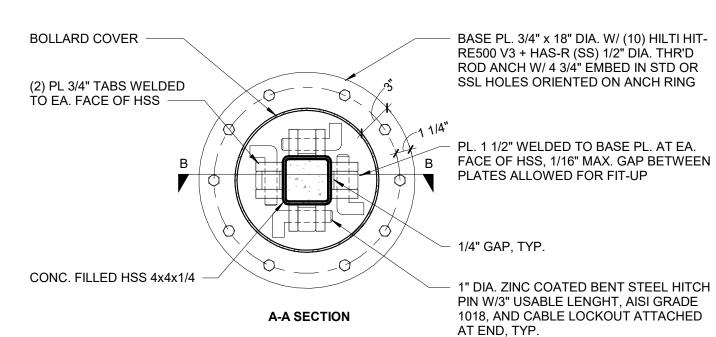

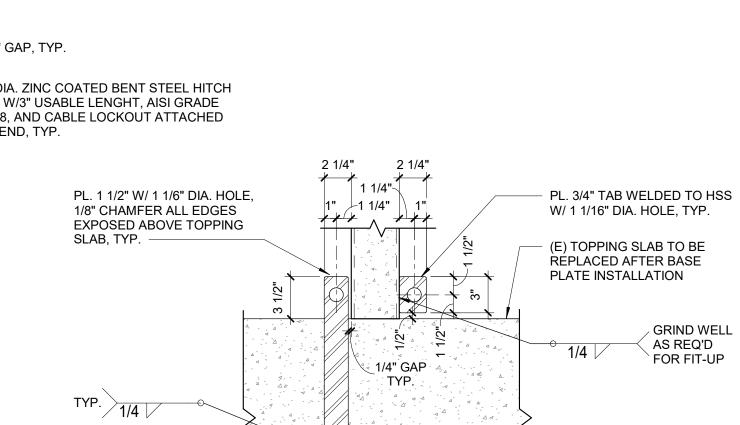



B-B SECTION

GRIND WELL ⟨ AS REQ'D FOR FIT-UP

BASE PL. 3/4"


— (E) STRUCTURAL SLAB

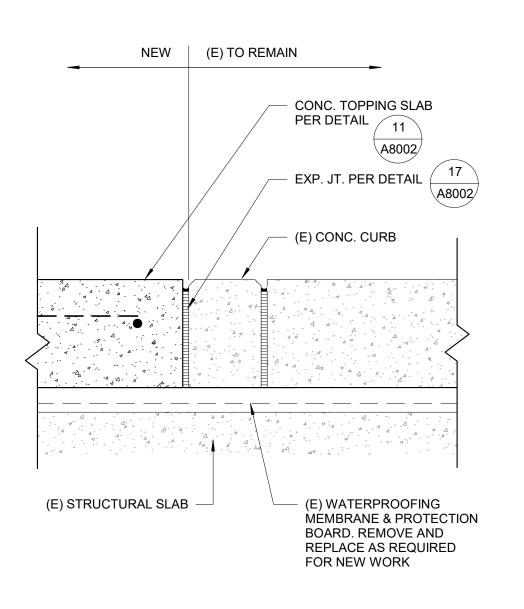

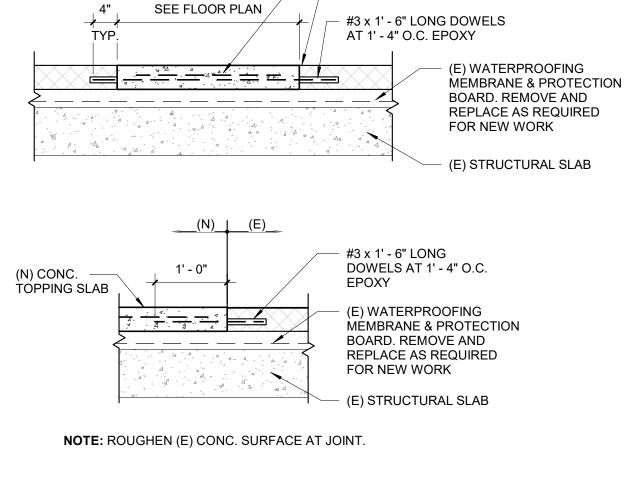


- #4 AT 1' - 4" O.C. EACH WAY


- SAWCUT AS REQUIRED

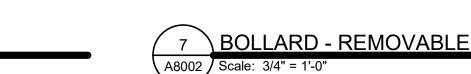





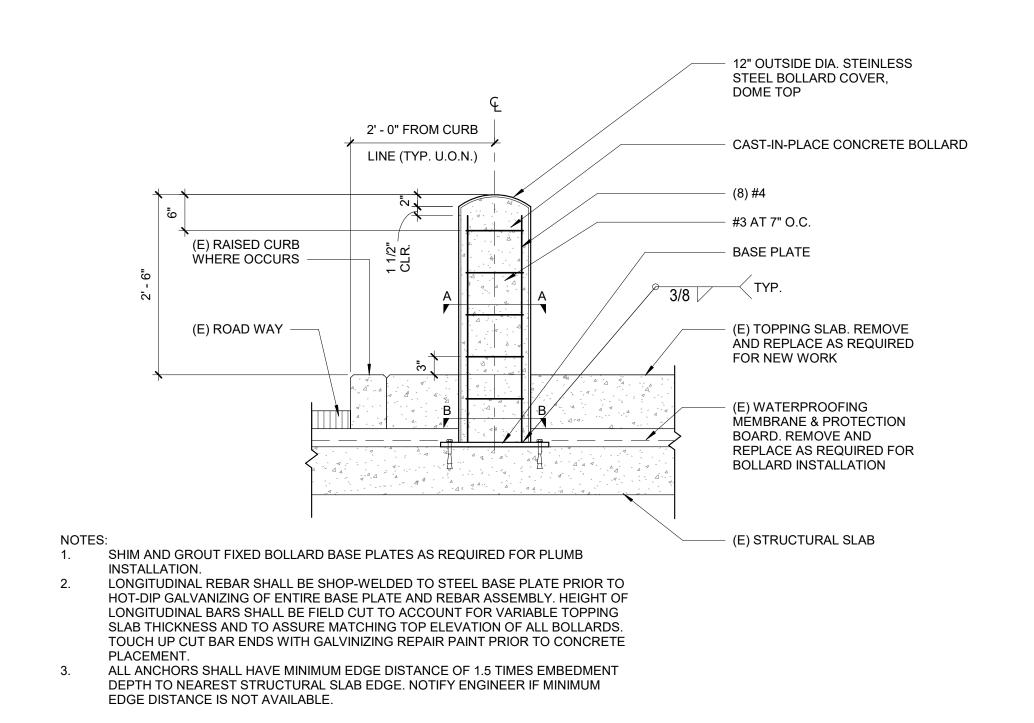

PENDING DETAIL COORDINATION

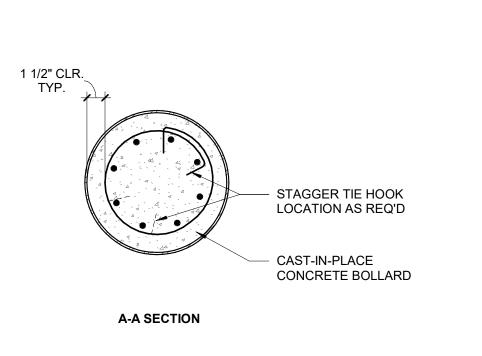

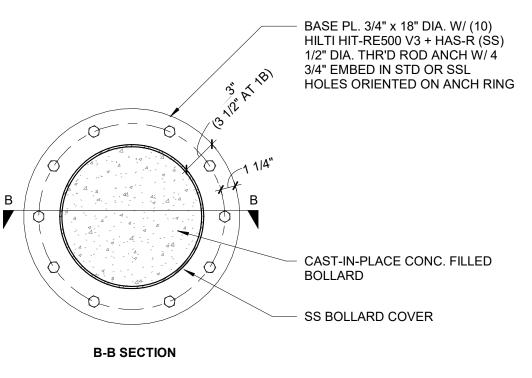

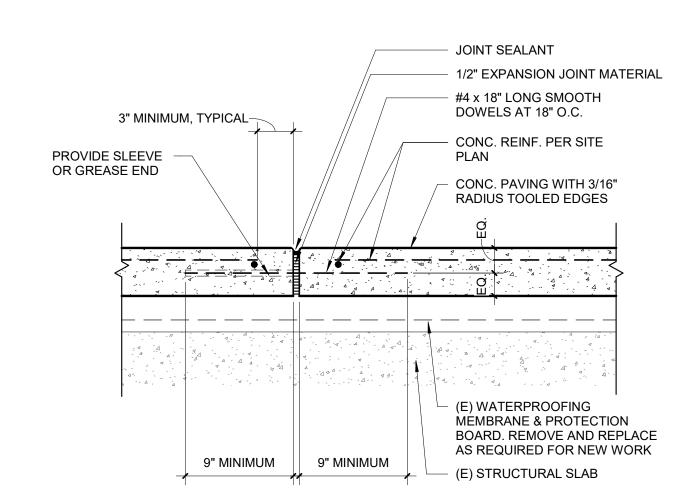

13 BOLLARD - REMOVABLE

SENIOR TECH. MGR.: DRAWN BY: SHEET TITLE .:

SHEET NO.:

A8002

ARCHITECTURAL

Author

As indicated

04/22/21

116535

1001 Wilshire Boulevard, Suite 100-3100,

Los Angeles, CA 90017, USA tel 213 769 0011 fax 213 769 0016 ibigroup.com

COPYRIGHT

This drawing has been prepared solely for the intended use, thus any reproduction or distribution for any purpose other than authorized by IBI Group is forbidden. Written dimensions shall have precedence over scaled dimensions. Contractors shall verify and be responsible for all dimensions and conditions on the job, and IBI Group shall be informed of any variations from the dimensions and conditions shown on the drawing. Shop drawings shall be submitted to IBI Group for general conformance before proceeding with fabrication.

IBI Group, A California Partnership

CONSULTANT:

STATE SEAL:

PROJECT

BUILDING

EXTERIOR

PHYSICAL

SECURITY

PROJECT NUMBER: DRAWING NUMBER:

APPROVAL SHEET NO.:

700 N. ALAMEDA ST.

LOS ANGELES, CA 90012

ADDRESS:

REVISIONS:

DELTA TITLE

HEADQUARTERS

IMPROVEMENTS

DATE BY

SPECIFICATION NO.: 2003

17 WALK - EXPANSION JOINT

NOTE: AT DETAIL 1B, USE BASE PL. 3/4"x19"DIA. W/(12) HILTI HIT-RE500 V3 + HAS-R (SS) 1/2" DIA. THR'D ROD ANCH W/ 3 3/4" EMBED IN STD OR SSL HOLES ORIENTED ON ANCH RING